

## MITREX / CLADIFY

41 RACINE ROAD

CLIENT:

CLADIFY / MITREX


ARCHITECT:

# CLADIFAB

CLADIFY / MITREX PREFAB WALL SYSTEM REV-08.1 (MODIFIED BACKSHEET)

APRIL 01, 2024

**NOTE: PRINT IN COLOR** 

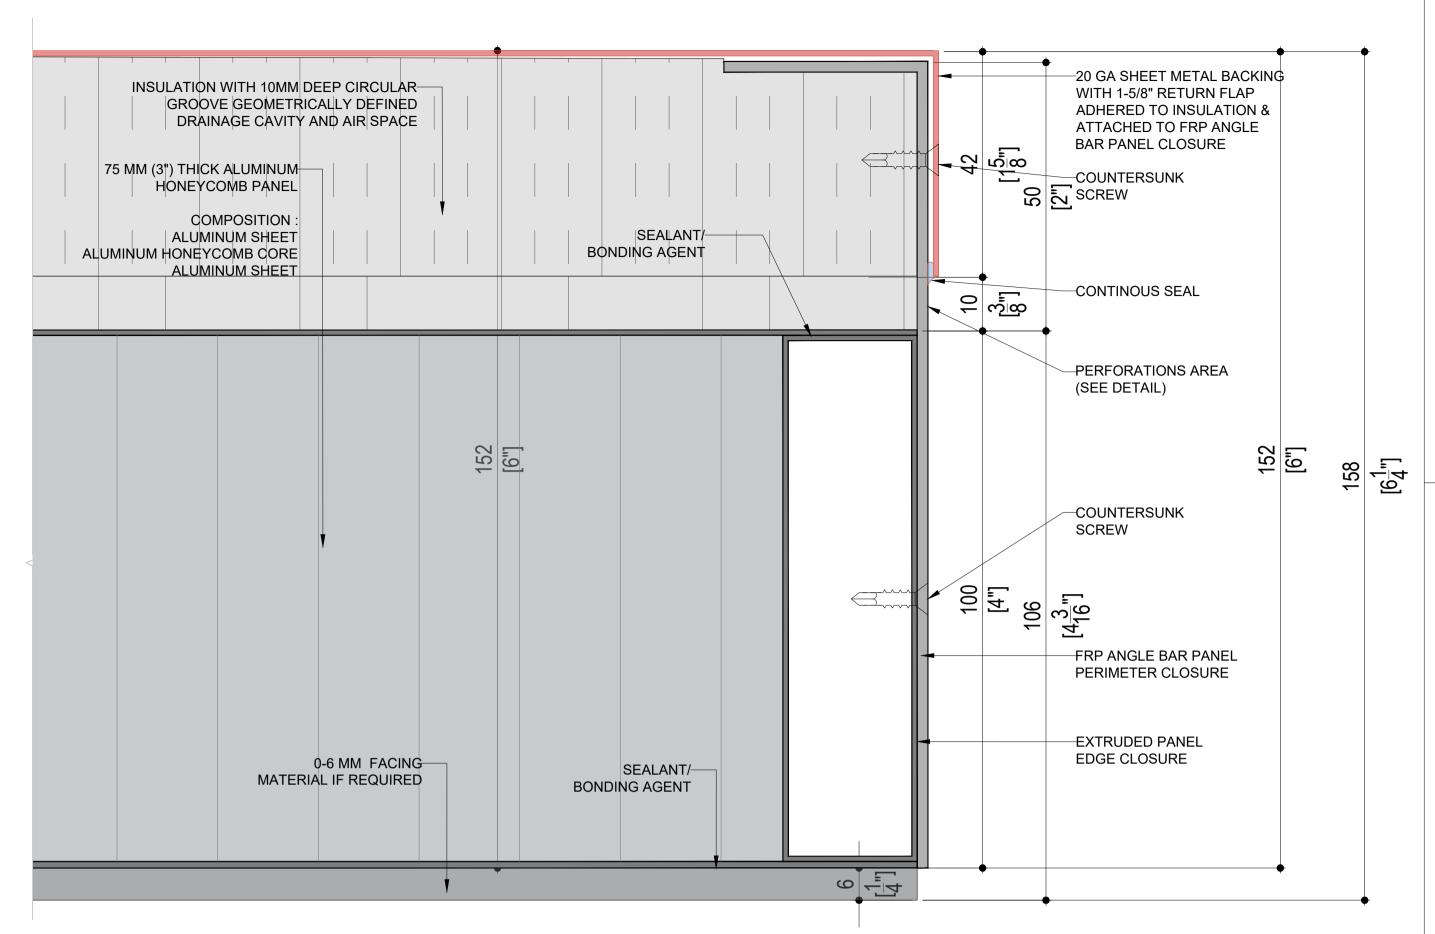

4" HONEYCOMB PANEL COMPONENTS SCALE: 1:1

NI-A


NI-A

-20 GA SHEET METAL BACKING INSULATION WITH 10MM DEEP CIRCULAR-WITH 1-5/8" RETURN FLAP GROOVE GEOMETRICALLY DEFINED ADHERED TO INSULATION & DRAINAGE CAVITY AND AIR SPACE ATTACHED TO FRP ANGLE BAR PANEL CLOSURE 42 8 3 75 MM (3") THICK ALUMINUM— -COUNTERSUNK HONEYCOMB PANEL SCREW COMPOSITION SEALANT/-ALUMINUM SHEET BONDING AGENT ALUMINUM HONEYCOMB CORE ALUMINUM SHEET -CONTINOUS SEAL 10 [\bar{8}] PERFORATIONS AREA (SEE DETAIL) 127 [5"] 127 [5"] 133 [5<sup>1</sup>] -COUNTERSUNK SCREW 75 [3"] 81 [3<sup>3</sup>"] FRP ANGLE BAR PANEL PERIMETER CLOSURE 0-6 MM FACING SEALANT/-MATERIAL IF REQUIRED **BONDING AGENT** EXTRUDED PANEL EDGE CLOSURE 9 14

3" HONEYCOMB PANEL COMPONENTS

SCALE: 1:1

PRE-FAB PANEL WEIGHT PANEL WEIGHT / SQ.FT. PANEL THICKNESS 5" THICK (NO FACING MATERIAL) 4.08 LBS / SQ.FT. 6" THICK (NO FACING MATERIAL) 4.29 LBS / SQ.FT.

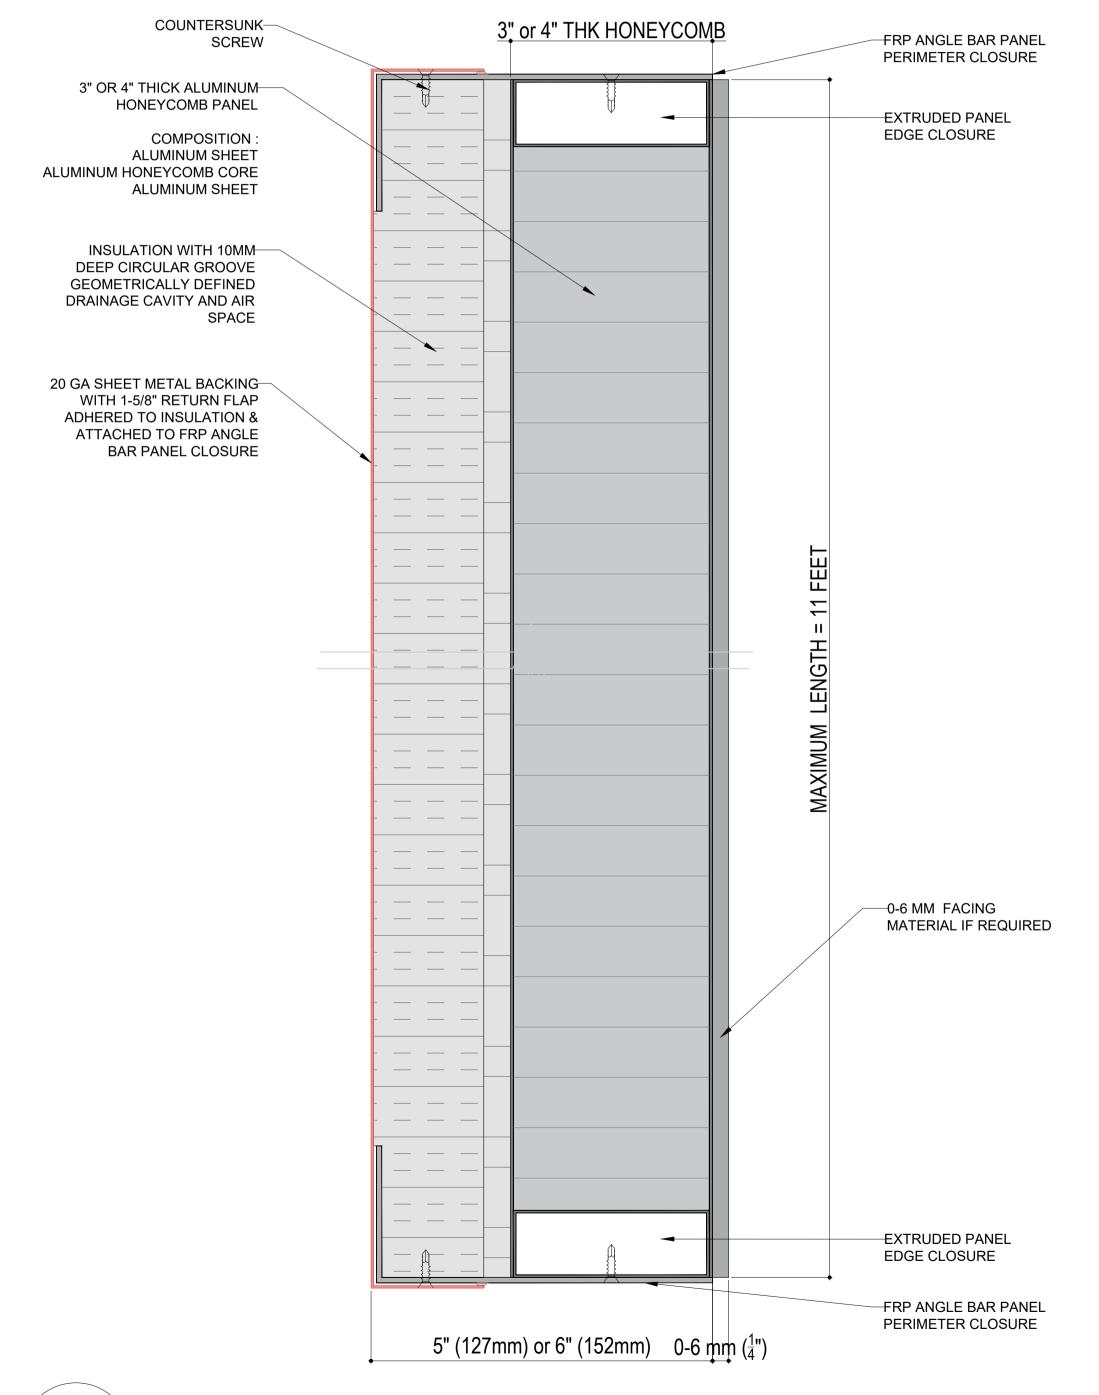

HONEYCOMB PANEL SECTION

SCALE: 1:2

NI-A



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- 2. ALL PANEL SIZES ARE BASED ON THE ARCHITECTURAL DRAWINGS, APPROVED SHOP DRAWINGS, AND SLAB EDGE MEASUREMENTS
- 3. ALL CLADIFY PANELS ARE PORCELAIN FACING WITH ALUMINUM HONEY COMB BACKING.

4. DUE TO THE SIZE OF THE PANELS, THE PRODUCTION MANAGER MAY SUGGEST THICKER

- ALUMINUM BACKING SYSTEM. 5. DUE TO THE SIZE OF THE PANELS, THE REQUIRED TEMPERATURE FOR INSTALLATION IS +12 °C.
- ALL HORIZONTAL AND VERTICAL JOINTS ARE 20mm UNLESS NOTED OTHERWISE. MAKE UP ALONG ENTIRE LENGTH TO ACCOUNT FOR DIMENSIONAL ROUNDING OF INDIVIDUAL STONE LENGTHS.
- 7. SITE CUT STONE TO SUIT CONDITIONS ARE REQUIRED
- 8. DO NOT SCALE DRAWING. 9. PANEL SIZE TOLERANCE IS -1-2 INCHES
- 10. DUE TO WALL ASSEMBLY DEPTH, CLADDING
- SYSTEM MAY VARY. 11. SYSTEM SIZE TO BE CONFIRMED.
- 12. PENETRATIONS TO BE SEALED 13. PRINT IN COLOR

#### ABBREVIATIONS:

CL = CLADIFY T/O = TOP OFB/O = BOTTOM OFREF. = REFERENCE/REFER M/E = MITERED EDGE

E/O = END OFC/O = CORNER OF TYP. = TYPICAL SIM. = SIMILAR F/O = FACE OF

#### SEAL



REV. YY-MM-DD DESCRIPTION

**ARCHITECT** 

CLIENT

PROJECT TITLE

**CLADIFAB CLADIFY/MITREX** PREFAB WALL SYSTEM

SHEET TITLE


PREFAB PANEL

INFORMATION


2024-04-01 SCALE: AS INDICATED DRAWN BY: GC MEASURED BY: CHECKED BY: AR / AS

DRAWING NO:

NI-A (Rev08.1) MODIFIED BACKSHEET

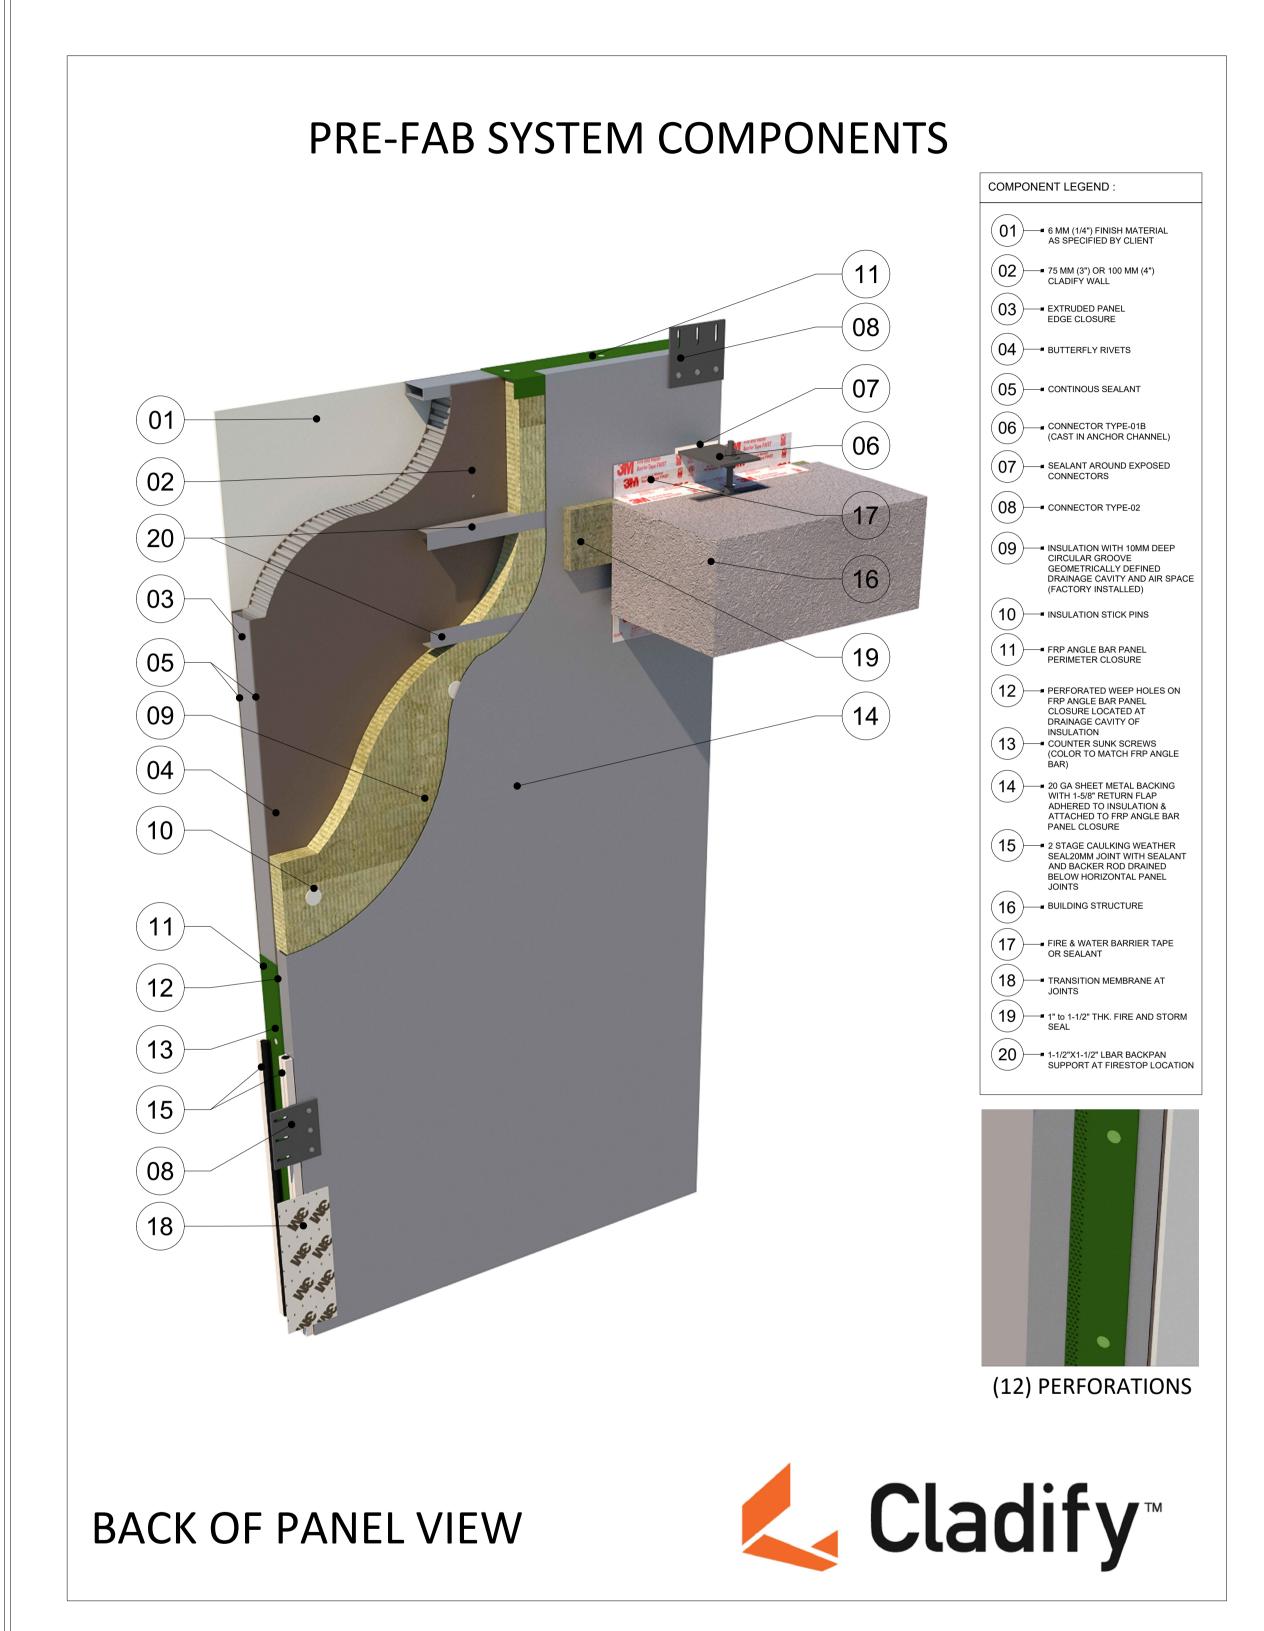

### PRE-FAB SYSTEM COMPONENTS

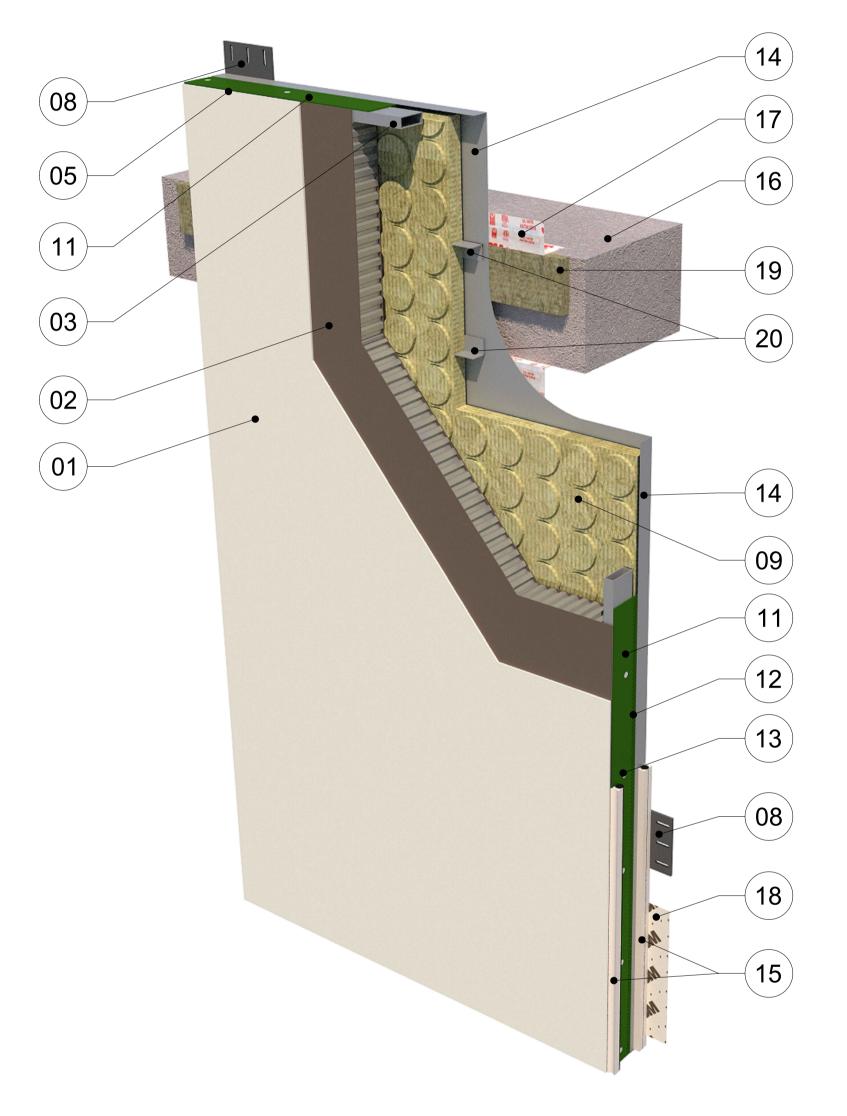

COMPONENT LEGEND : 6 MM (1/4") FINISH MATERIAL AS SPECIFIED BY CLIENT 75 MM (3") OR 100 MM (4") CLADIFY WALL (03) EXTRUDED PANEL EDGE CLOSURE (04) BUTTERFLY RIVETS (05)— CONTINOUS SEALANT (06) CONNECTOR TYPE-01B (CAST IN ANCHOR CHANNEL) (07)— SEALANT AROUND EXPOSED (08) CONNECTOR TYPE-02 (09) INSULATION WITH 10MM DEEP CIRCULAR GROOVE GEOMETRICALLY DEFINED DRAINAGE CAVITY AND AIR SPACE (FACTORY INSTALLED) (10) INSULATION STICK PINS (11) FRP ANGLE BAR PANEL

> (14) = 20 GA SHEET METAL BACKING WITH 1-5/8" RETURN FLAP ADHERED TO INSULATION &

ATTACHED TO FRP ANGLE BAR PANEL CLOSURE —■ 2 STAGE CAULKING WEATHER SEAL20MM JOINT WITH SEALANT AND BACKER ROD DRAINED

BELOW HORIZONTAL PANEL (16)— BUILDING STRUCTURE

17 FIRE & WATER BARRIER TAPE OR SEALANT

18 TRANSITION MEMBRANE AT

19 1" to 1-1/2" THK. FIRE AND STORM SEAL

20 1-1/2"X1-1/2" LBAR BACKPAN SUPPORT AT FIRESTOP LOCATION



(12) PERFORATIONS

FRONT OF PANEL VIEW





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ALUMINUM BACKING SYSTEM. DUE TO THE SIZE OF THE PANELS, THE REQUIRED TEMPERATURE FOR INSTALLATION IS +12 °C.

6. ALL HORIZONTAL AND VERTICAL JOINTS ARE 20mm UNLESS NOTED OTHERWISE. MAKE UP ALONG ENTIRE LENGTH TO ACCOUNT FOR DIMENSIONAL ROUNDING OF INDIVIDUAL STONE LENGTHS.

E/O = END OF

C/O = CORNER OF

TYP. = TYPICAL

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7. SITE CUT STONE TO SUIT CONDITIONS ARE REQUIRED 8. DO NOT SCALE DRAWING.

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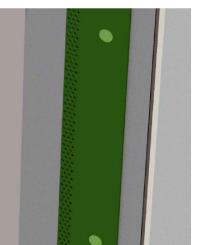
REF. = REFERENCE/REFER

CL = CLADIFY

T/O = TOP OF

12) PERFORATED WEEP HOLES ON FRP ANGLE BAR PANEL CLOSURE LOCATED AT DRAINAGE CAVITY OF

COUNTER SUNK SCREWS
(COLOR TO MATCH FRP ANGLE



PROJECT TITLE

CLIENT

**ARCHITECT** 

**CLADIFAB** CLADIFY/MITREX PREFAB WALL SYSTEM

REV. YY-MM-DD DESCRIPTION

SHEET TITLE

**CLADIFY PANEL COMPONENTS** 


AS INDICATED DRAWN BY: GC MEASURED BY: CHECKED BY: AR / AS

DRAWING NO:

NI-B (Rev08.1) MODIFIED BACKSHEET

## **CLADIFY PANEL COMPOSITION:**

### MITREX PANEL COMPOSITION:

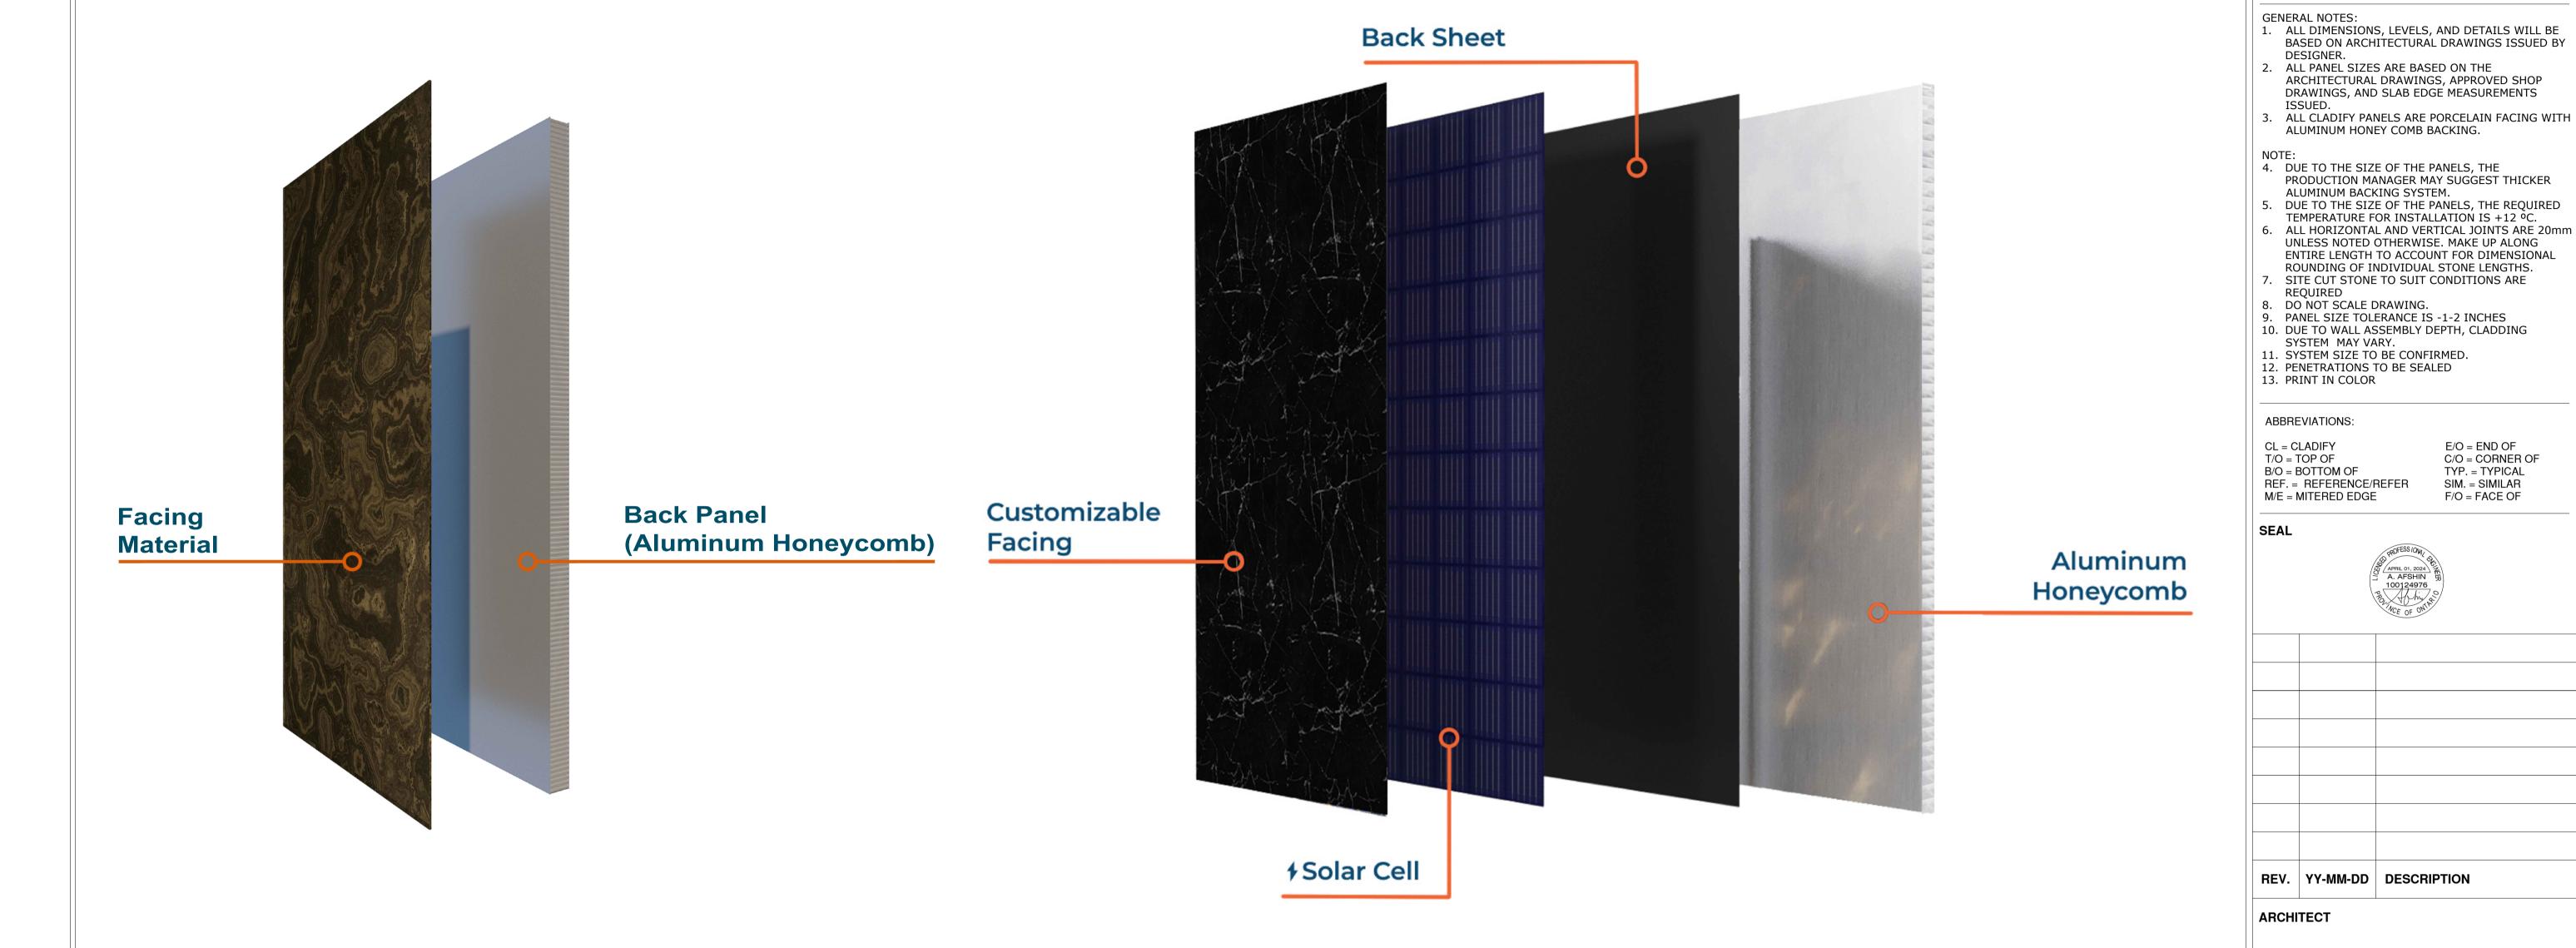

## INTERCHANGEABLE ARCHITECTURAL FINISHES

NATURAL STONE FACING


Stone Cladding Materials

PORCELAIN FACING

BRICK FACING



FOR COMPLETE ARCHITECTURAL FINISHES OPTIONS:

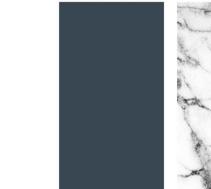

OPTIONS:

FOR COMPLETE **BIPV FINISHES** 

**CLADIFAB** CLADIFY/MITREX PREFAB WALL SYSTEM

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SHEET TITLE

PROJECT TITLE

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ARCHITECTURAL FINISHES

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SCALE: AS INDICATED DRAWN BY: GC
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**DRAWING NO:** 

NI-C (Rev08.1) MODIFIED BACKSHEET



Porcelain Cladding Materials

**Brick Cladding Materials** 


PAINTED/COATED METAL FACING



MITREX BIPV FACING





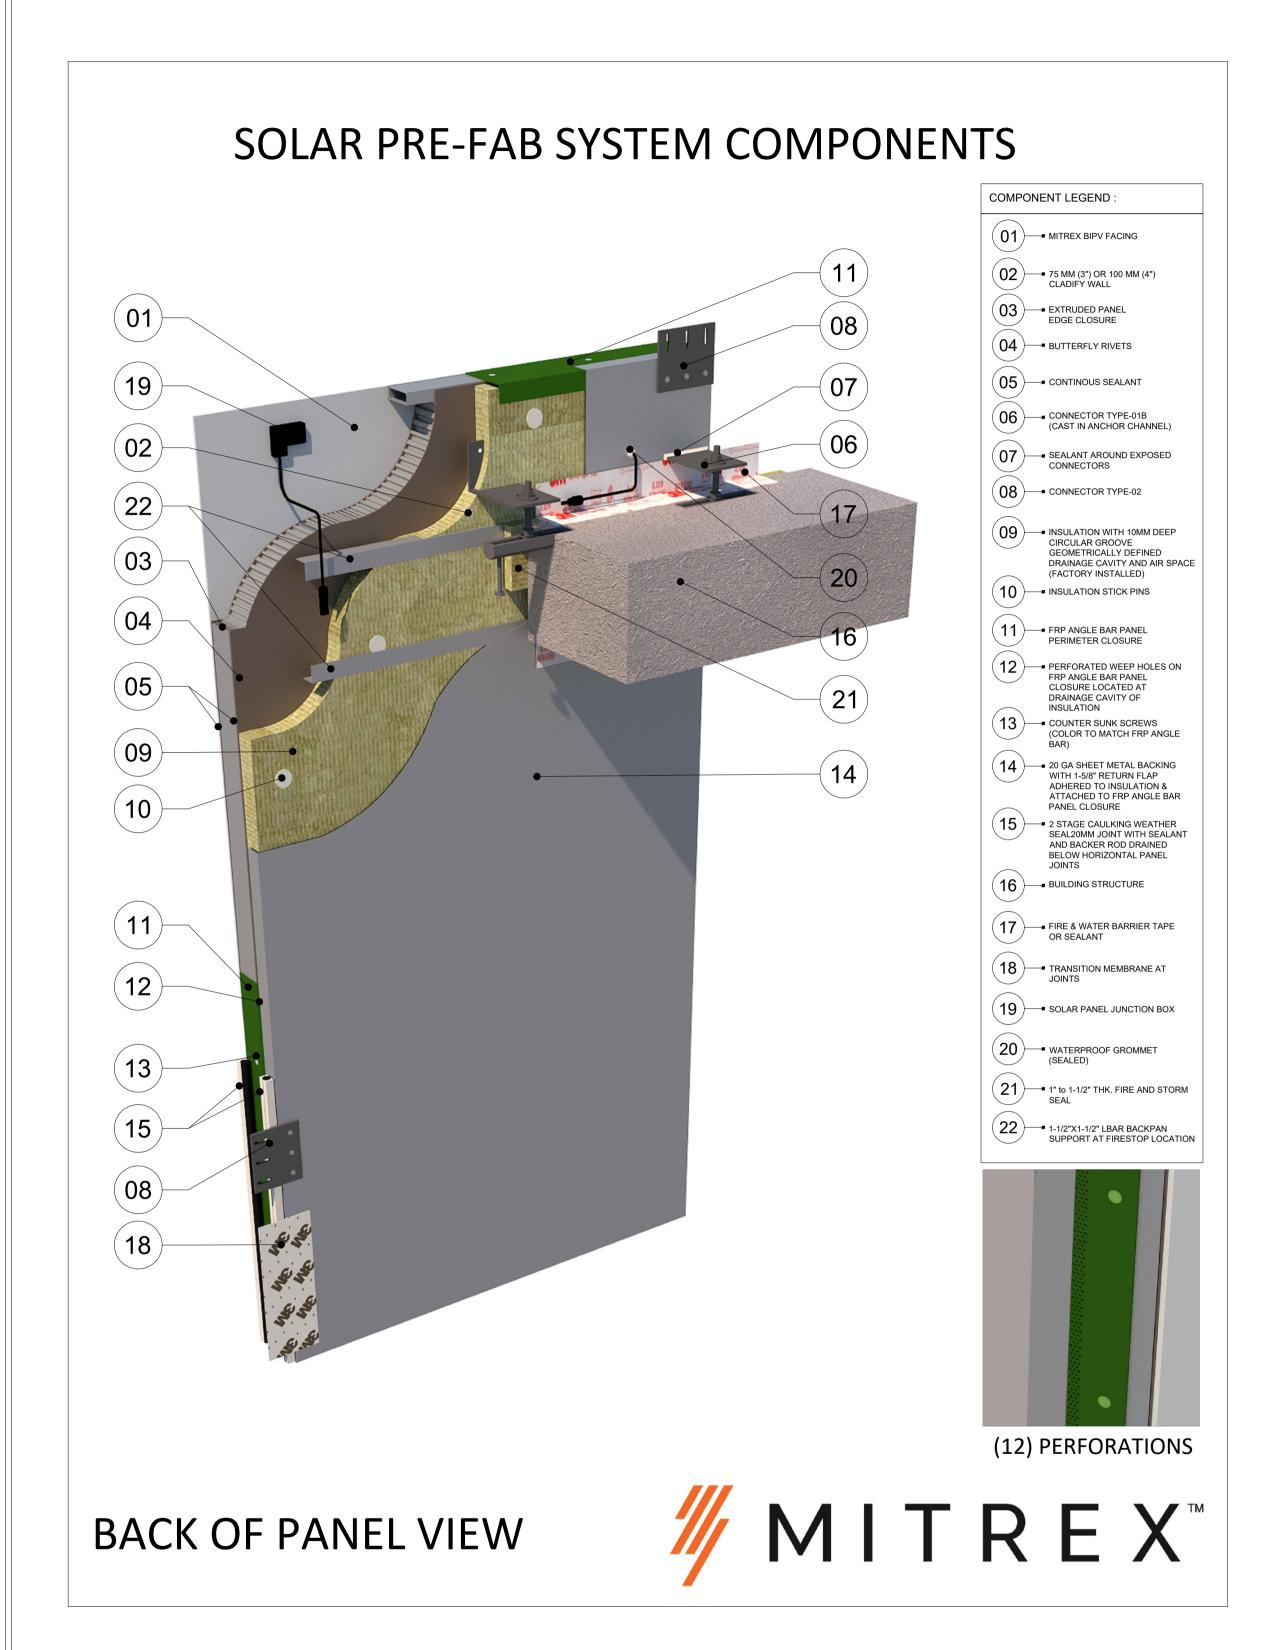

### SOLAR PRE-FAB SYSTEM COMPONENTS COMPONENT LEGEND : (01) → MITREX BIPV FACING 75 MM (3") OR 100 MM (4") CLADIFY WALL (03) EXTRUDED PANEL EDGE CLOSURE (04) BUTTERFLY RIVETS (05) — CONTINOUS SEALANT CAST IN ANCHOR CHANN (CAST IN ANCHOR CHANNEL) —■ SEALANT AROUND EXPOSED CONNECTORS ( **08** ) → CONNECTOR TYPE-02 ─ INSULATION WITH 10MM DEEP CIRCULAR GROOVE GEOMETRICALLY DEFINED DRAINAGE CAVITY AND AIR SPACE (FACTORY INSTALLED) (10) INSULATION STICK PINS (11)—FRP ANGLE BAR PANEL PERIMETER CLOSURE 12) PERFORATED WEEP HOLES ON FRP ANGLE BAR PANEL CLOSURE LOCATED AT DRAINAGE CAVITY OF (13) — COUNTER SUNK SCREWS (COLOR TO MATCH FRP ANGLE 20 GA SHEET METAL BACKING WITH 1-5/8" RETURN FLAP ADHERED TO INSULATION & ATTACHED TO FRP ANGLE BAR PANEL CLOSURE → 2 STAGE CAULKING WEATHER SEAL20MM JOINT WITH SEALANT AND BACKER ROD DRAINED BELOW HORIZONTAL PANEL (16) — BUILDING STRUCTURE (17) — FIRE & WATER BARRIER TAPE (18) TRANSITION MEMBRANE AT (19) solar panel junction box 20 waterproof grommet (SEALED) 21 1" to 1-1/2" THK. FIRE AND STORM SEAL 22 1-1/2"X1-1/2" LBAR BACKPAN SUPPORT AT FIRESTOP LOCATION (18) (12) PERFORATIONS FRONT OF PANEL VIEW





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M/E = MITERED EDGE

- 10. DUE TO WALL ASSEMBLY DEPTH, CLADDING SYSTEM MAY VARY.
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REV. YY-MM-DD DESCRIPTION

F/O = FACE OF

**MITREX** 

SHEET TITLE

**ARCHITECT** 

CLIENT

PROJECT TITLE

MITREX PANEL COMPONENTS

**CLADIFAB** 

CLADIFY/MITREX


PREFAB WALL SYSTEM

#### INFORMATION

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#### **DRAWING NO:**

NI-D (Rev08.1) MODIFIED BACKSHEET



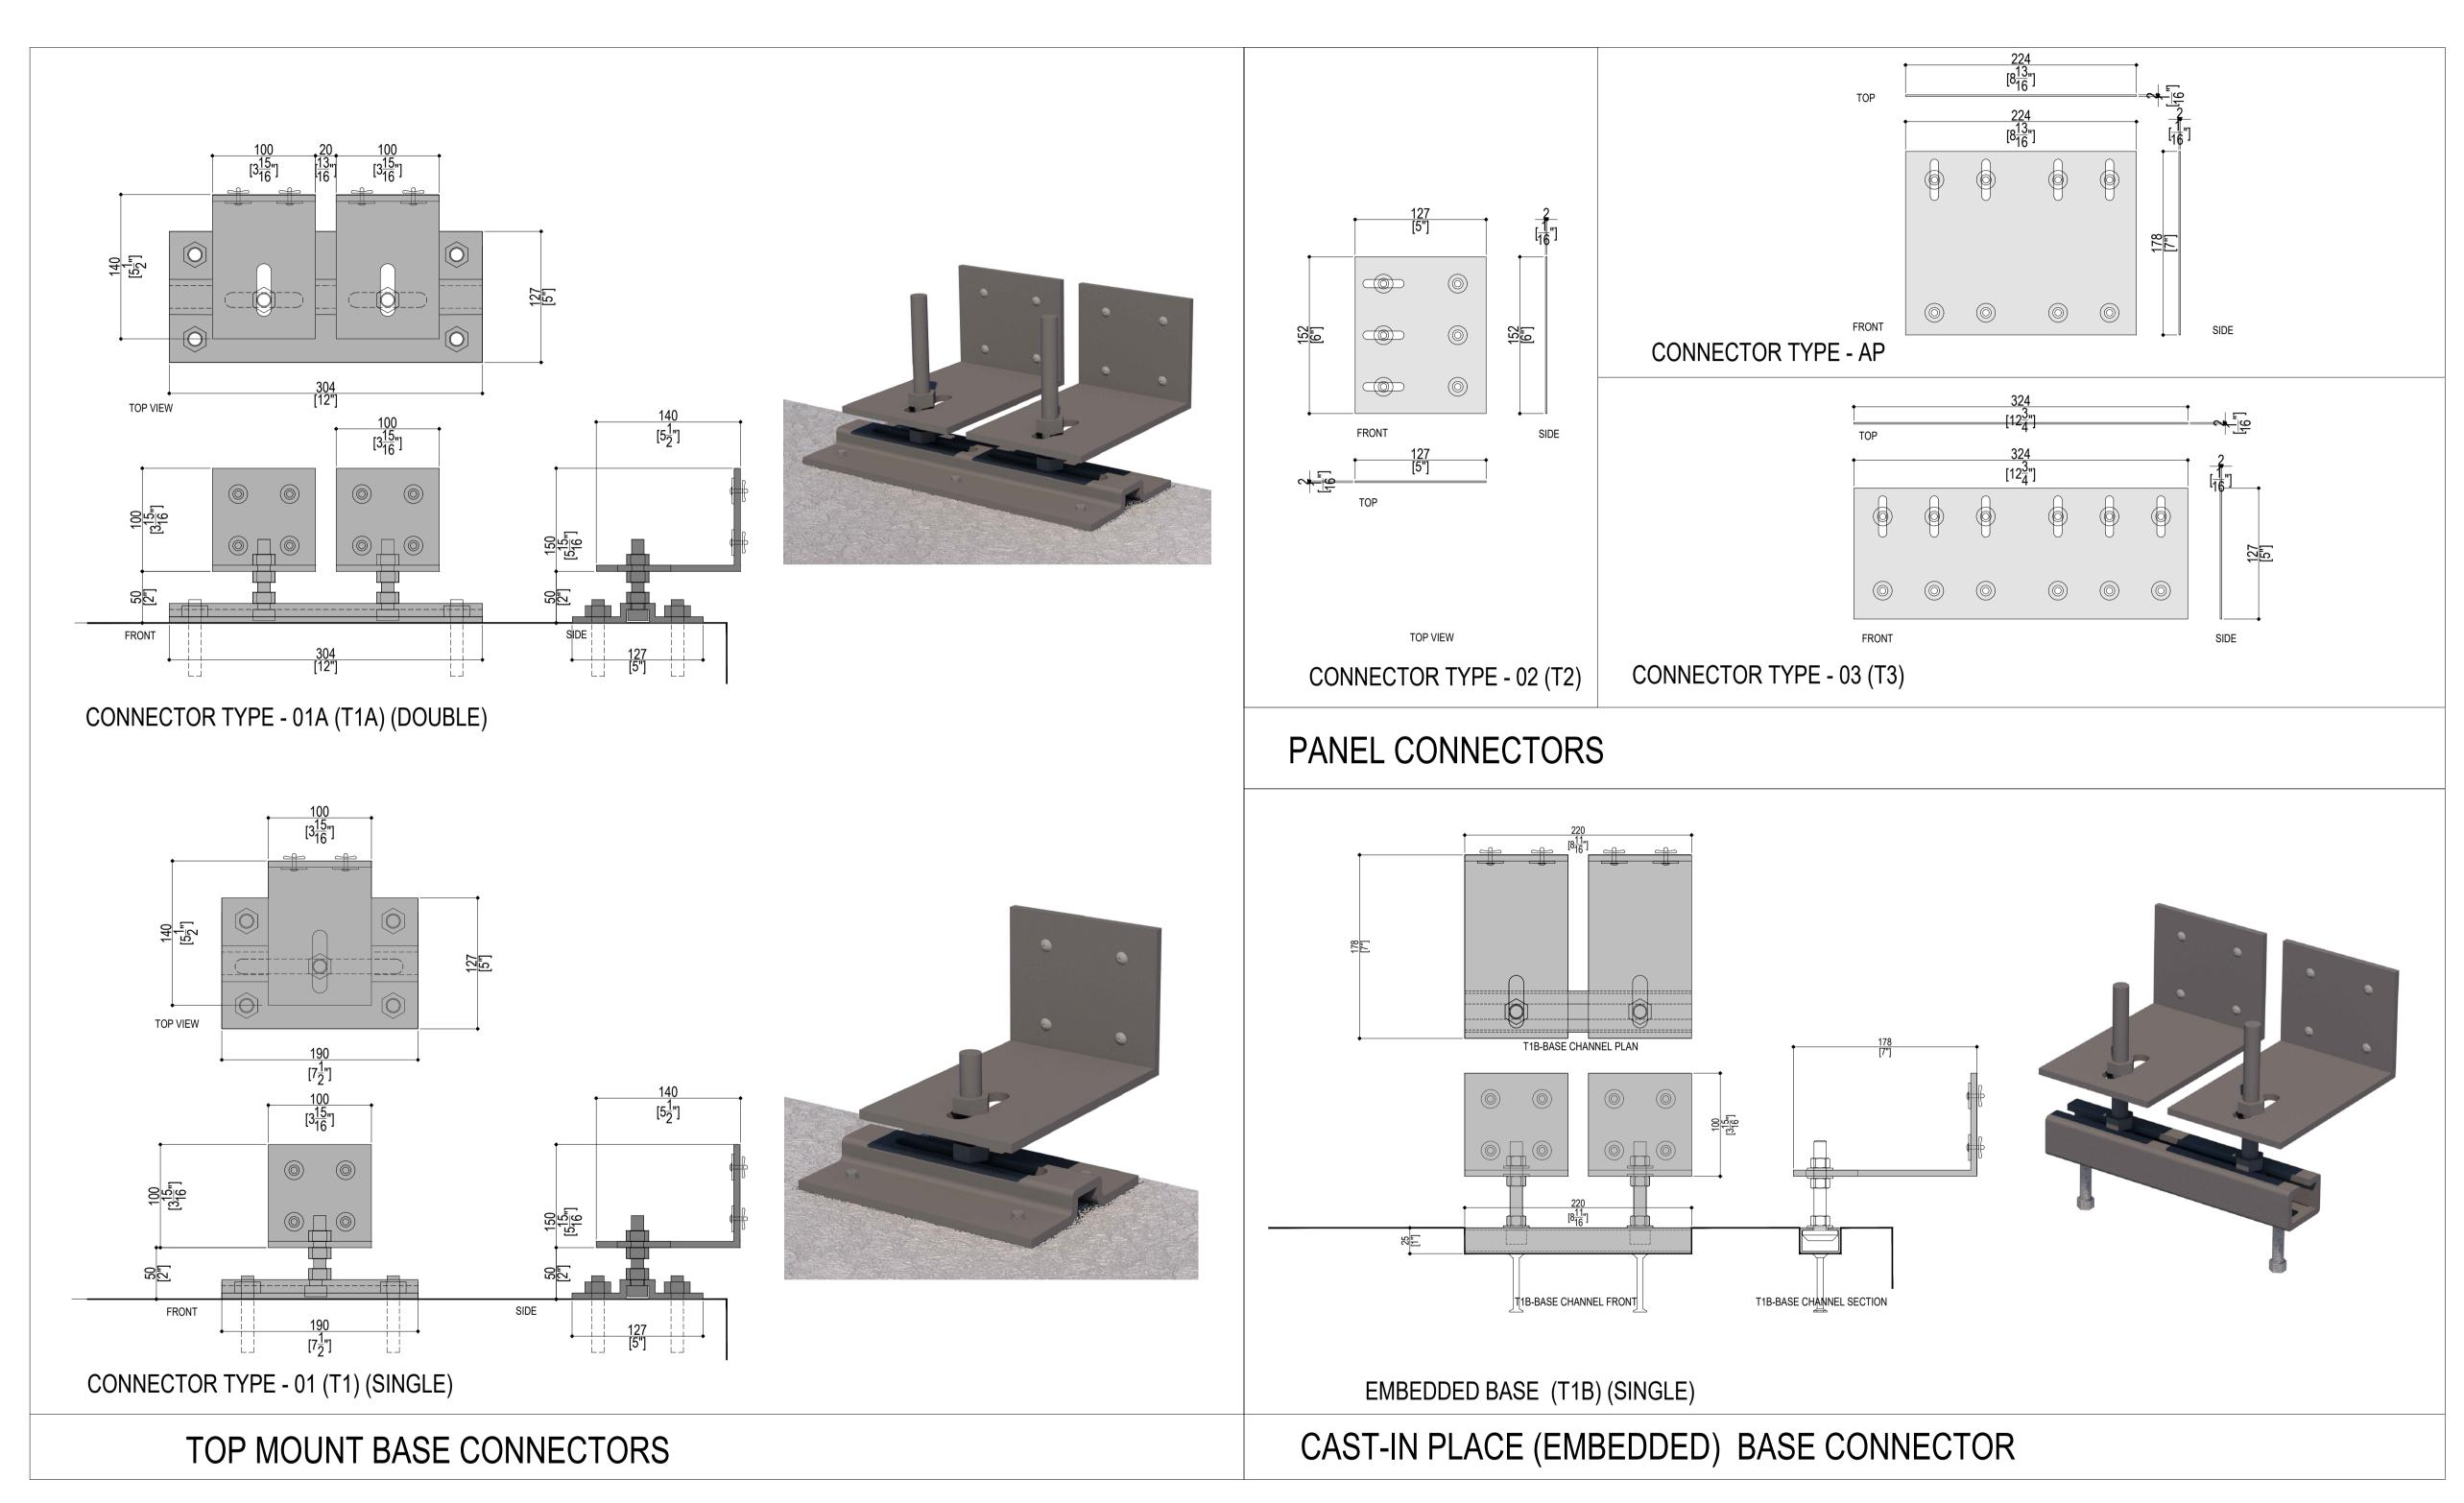



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PROJECT TITLE

**CLADIFAB** CLADIFY/MITREX PREFAB WALL SYSTEM

SHEET TITLE


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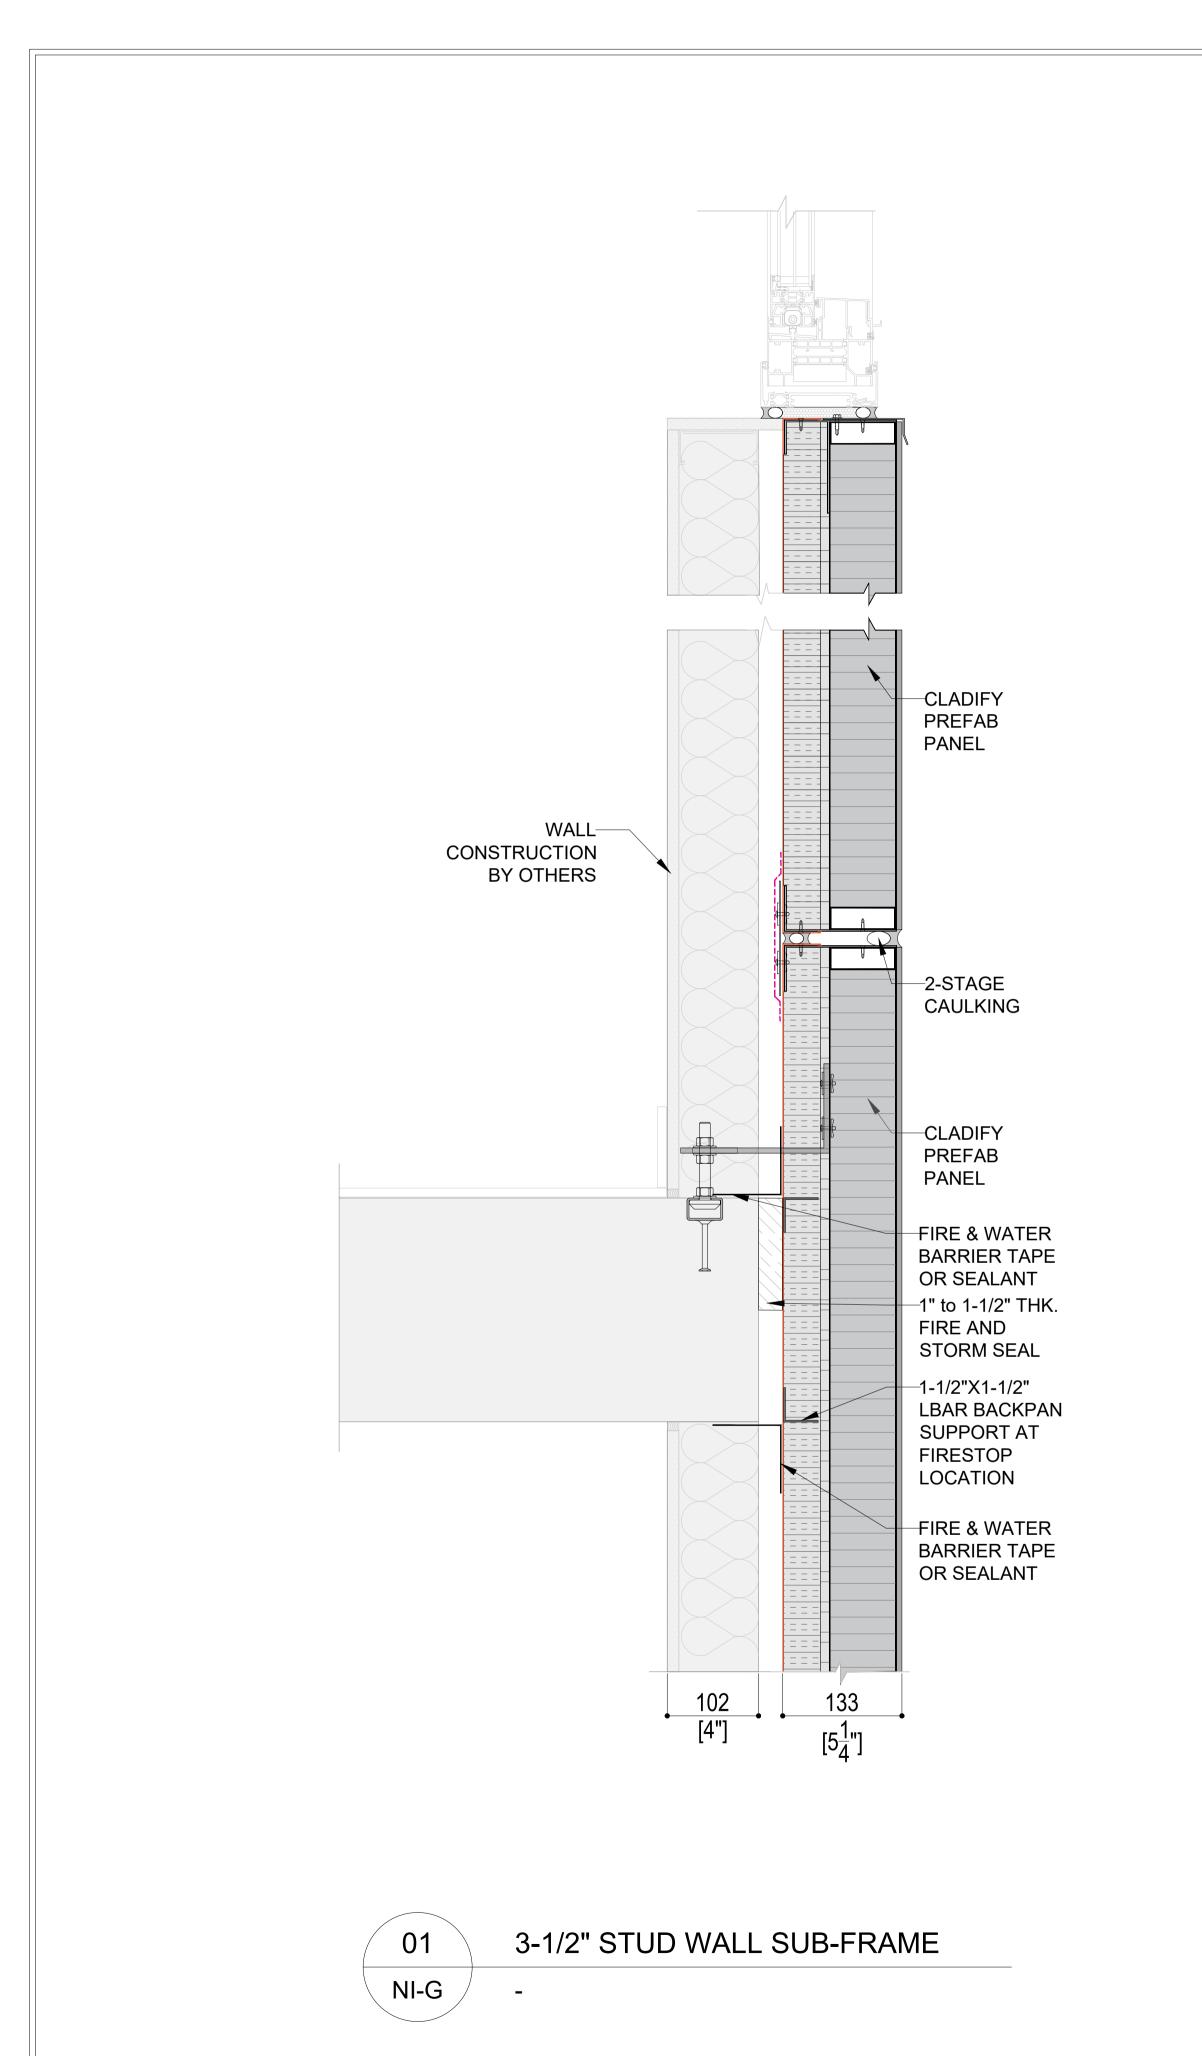
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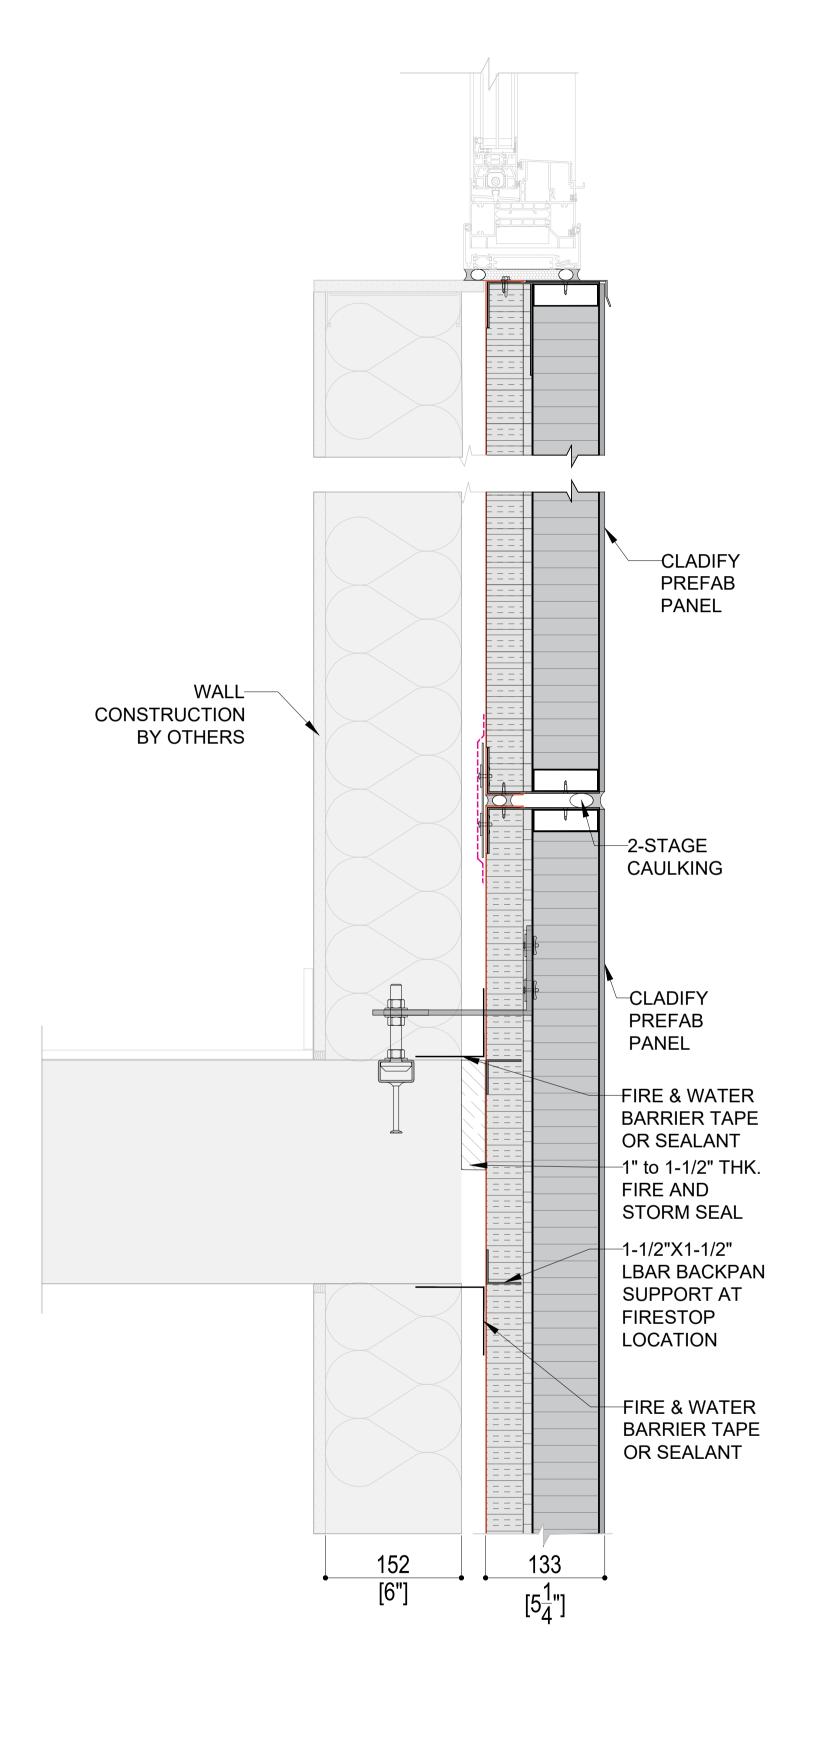
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### DRAWING NO:

NI-E (Rev08.1) MODIFIED BACKSHEET





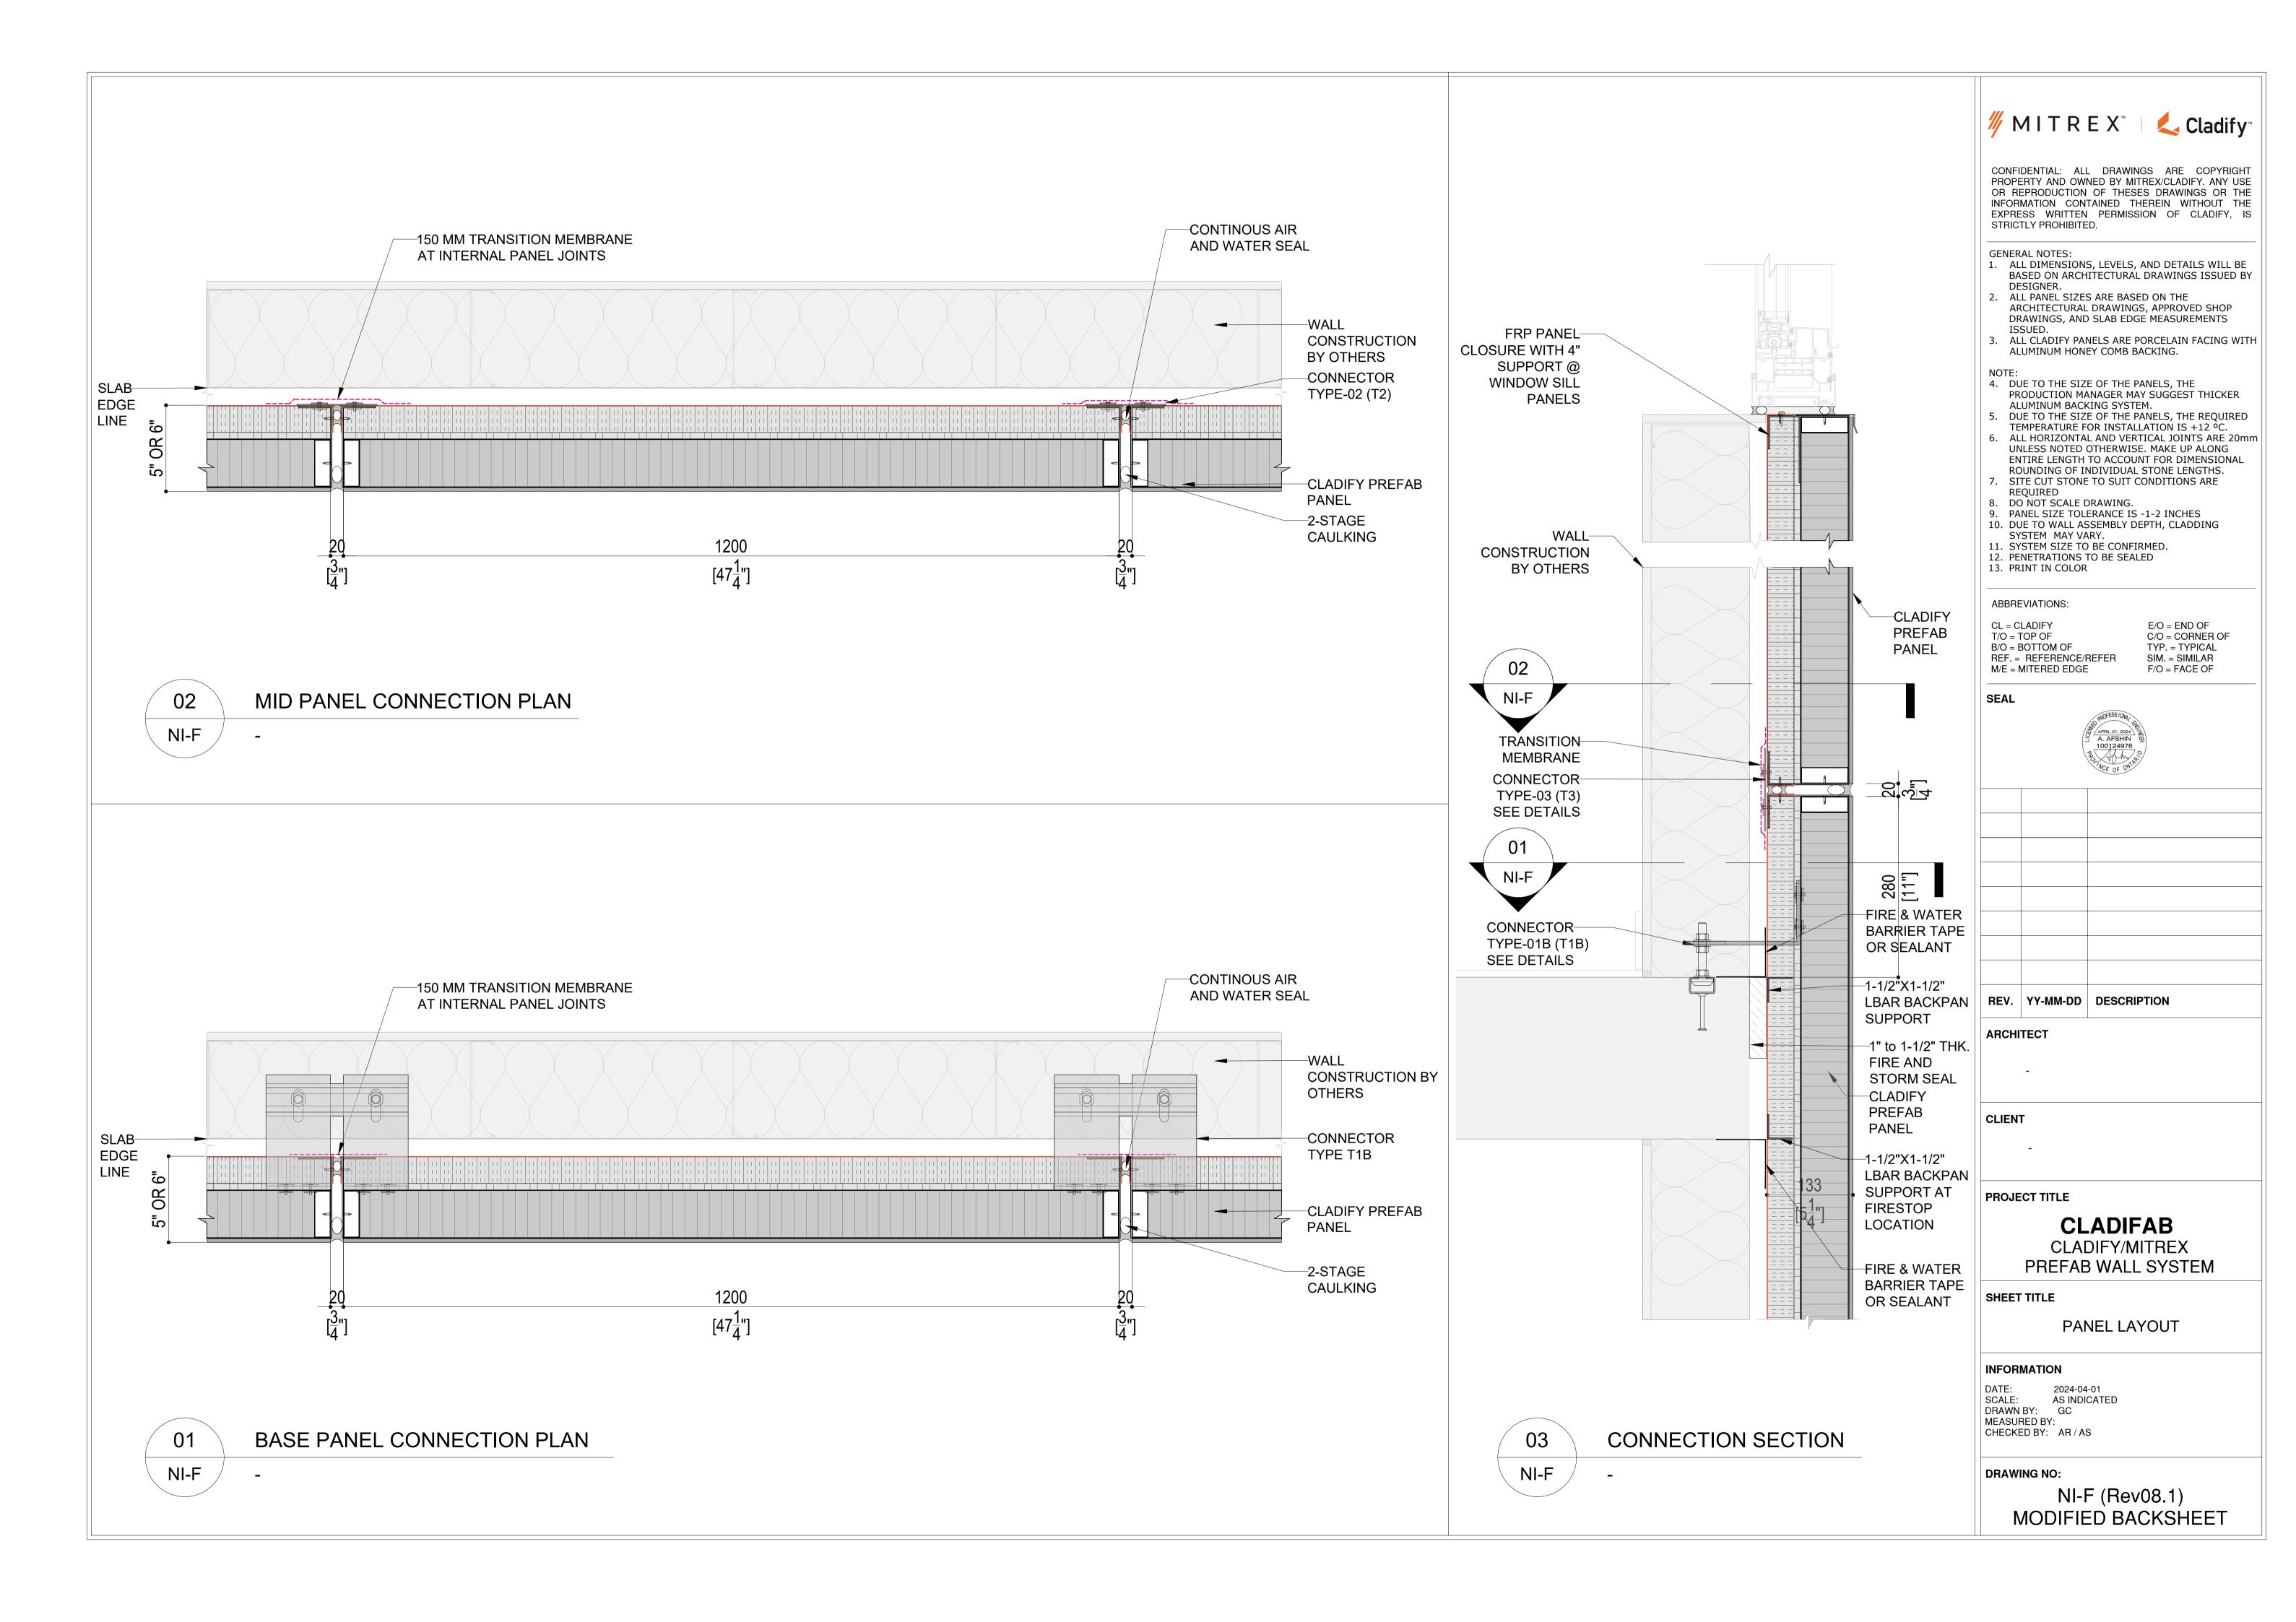

6" STUD WALL SUB-FRAME

NI-G





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**CLADIFAB** CLADIFY/MITREX PREFAB WALL SYSTEM

SHEET TITLE


WALL SYSTEM DEPTH


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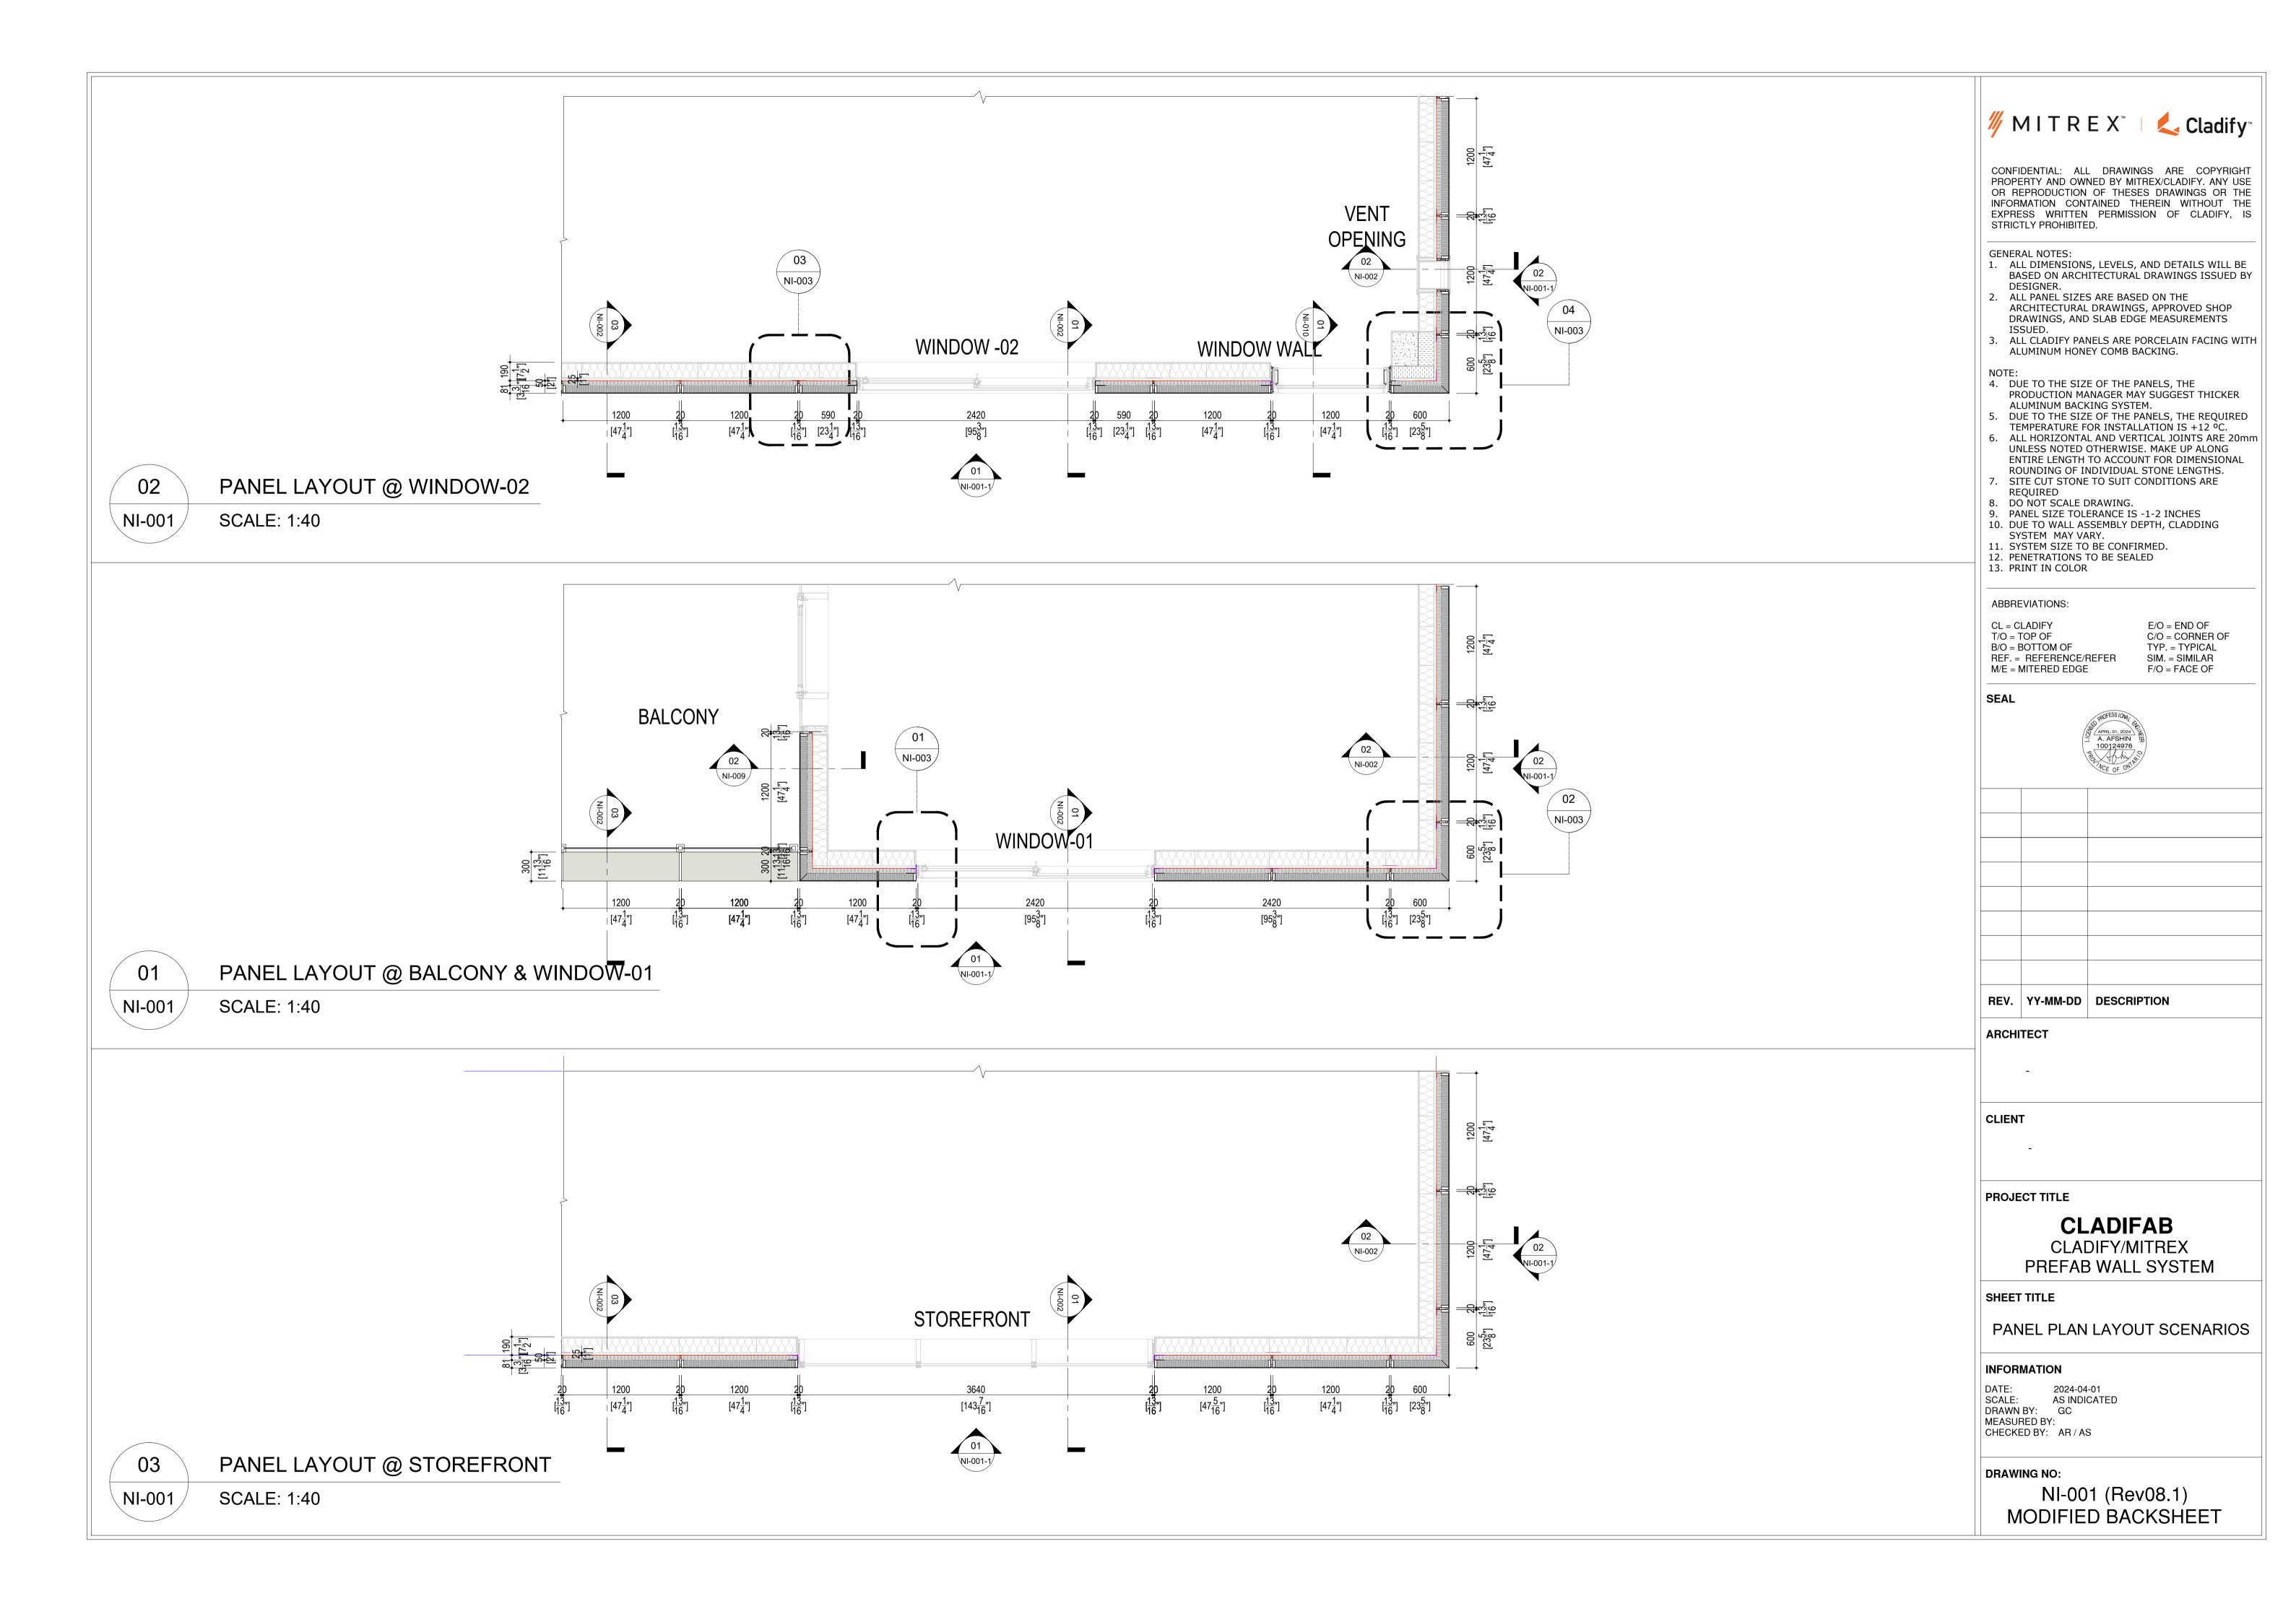
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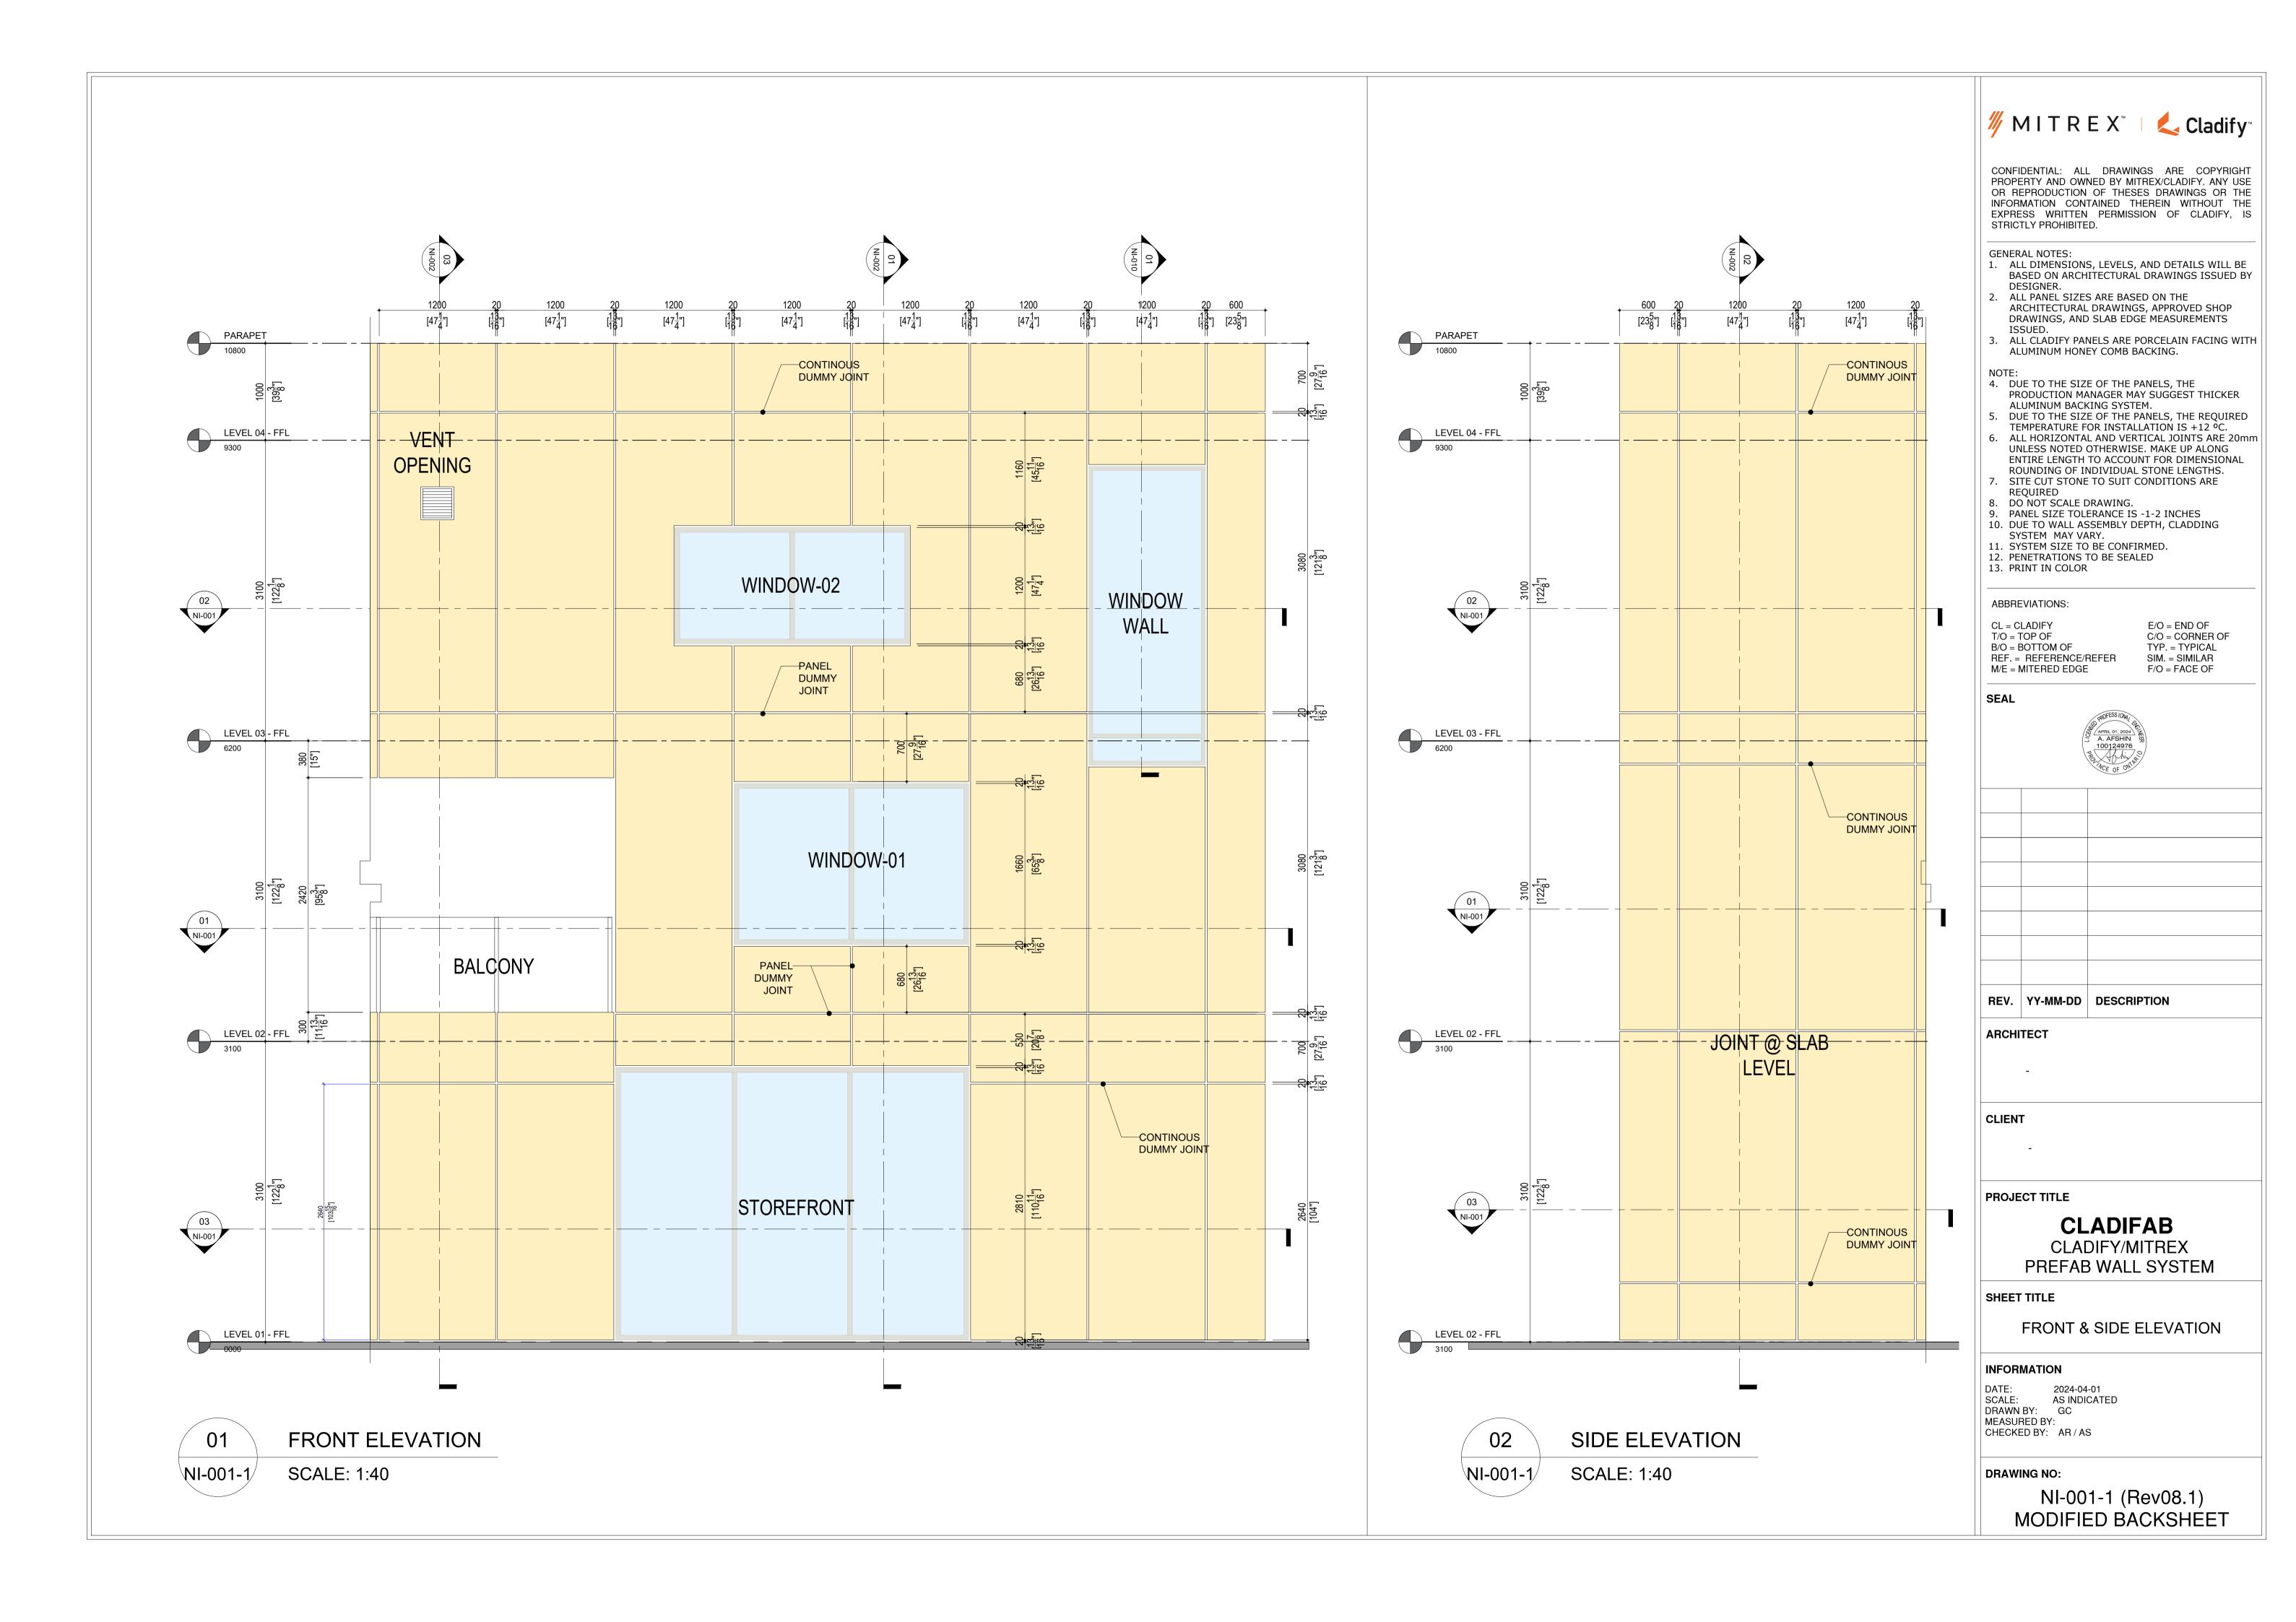
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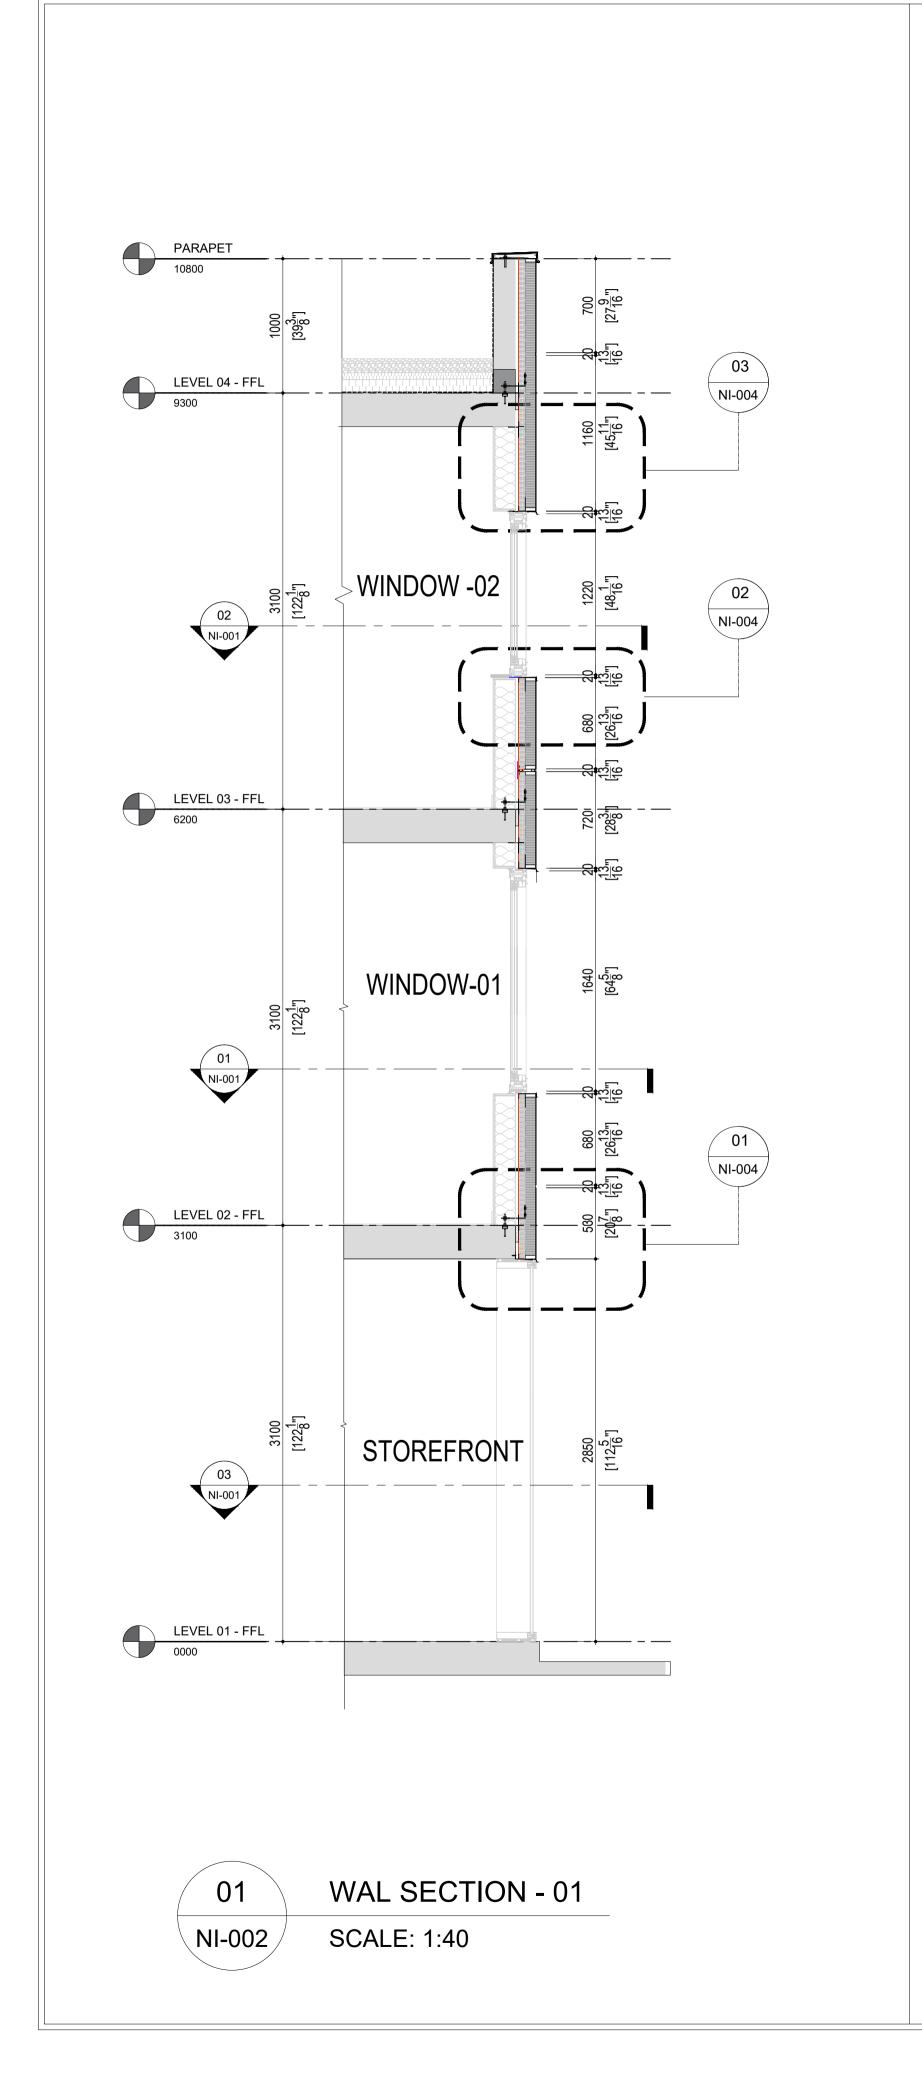
NI-G (Rev08.1) MODIFIED BACKSHEET










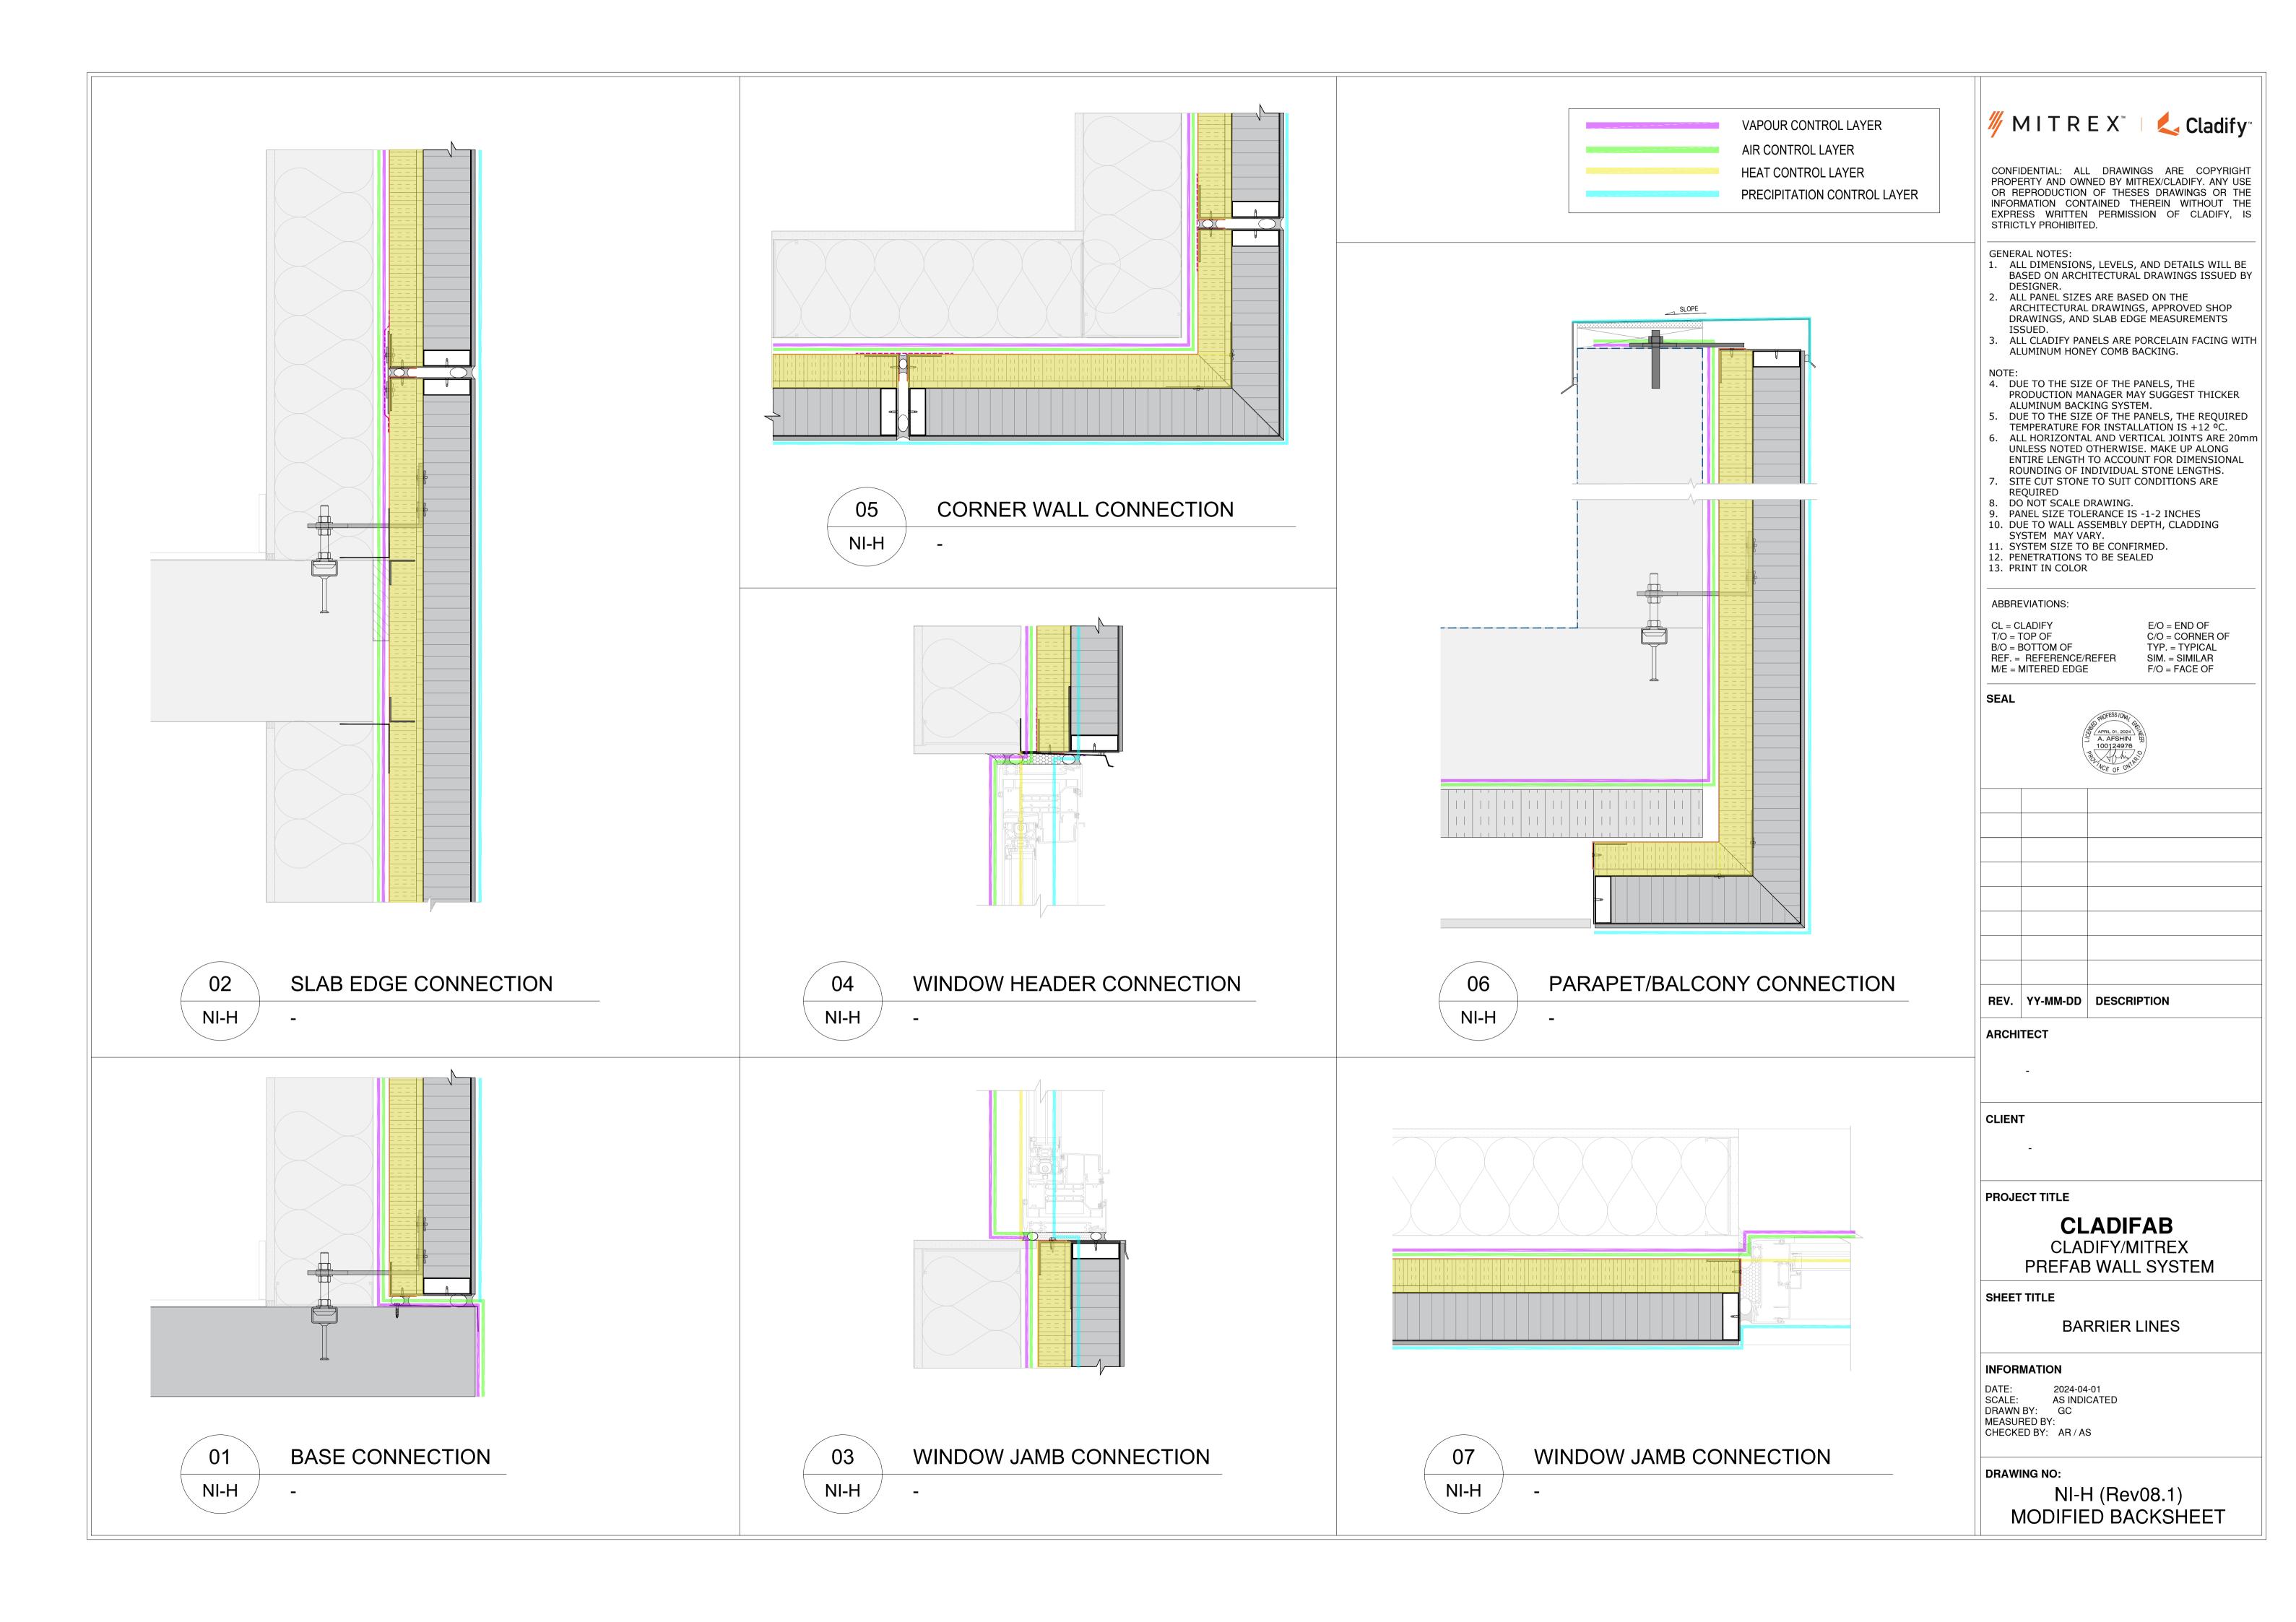

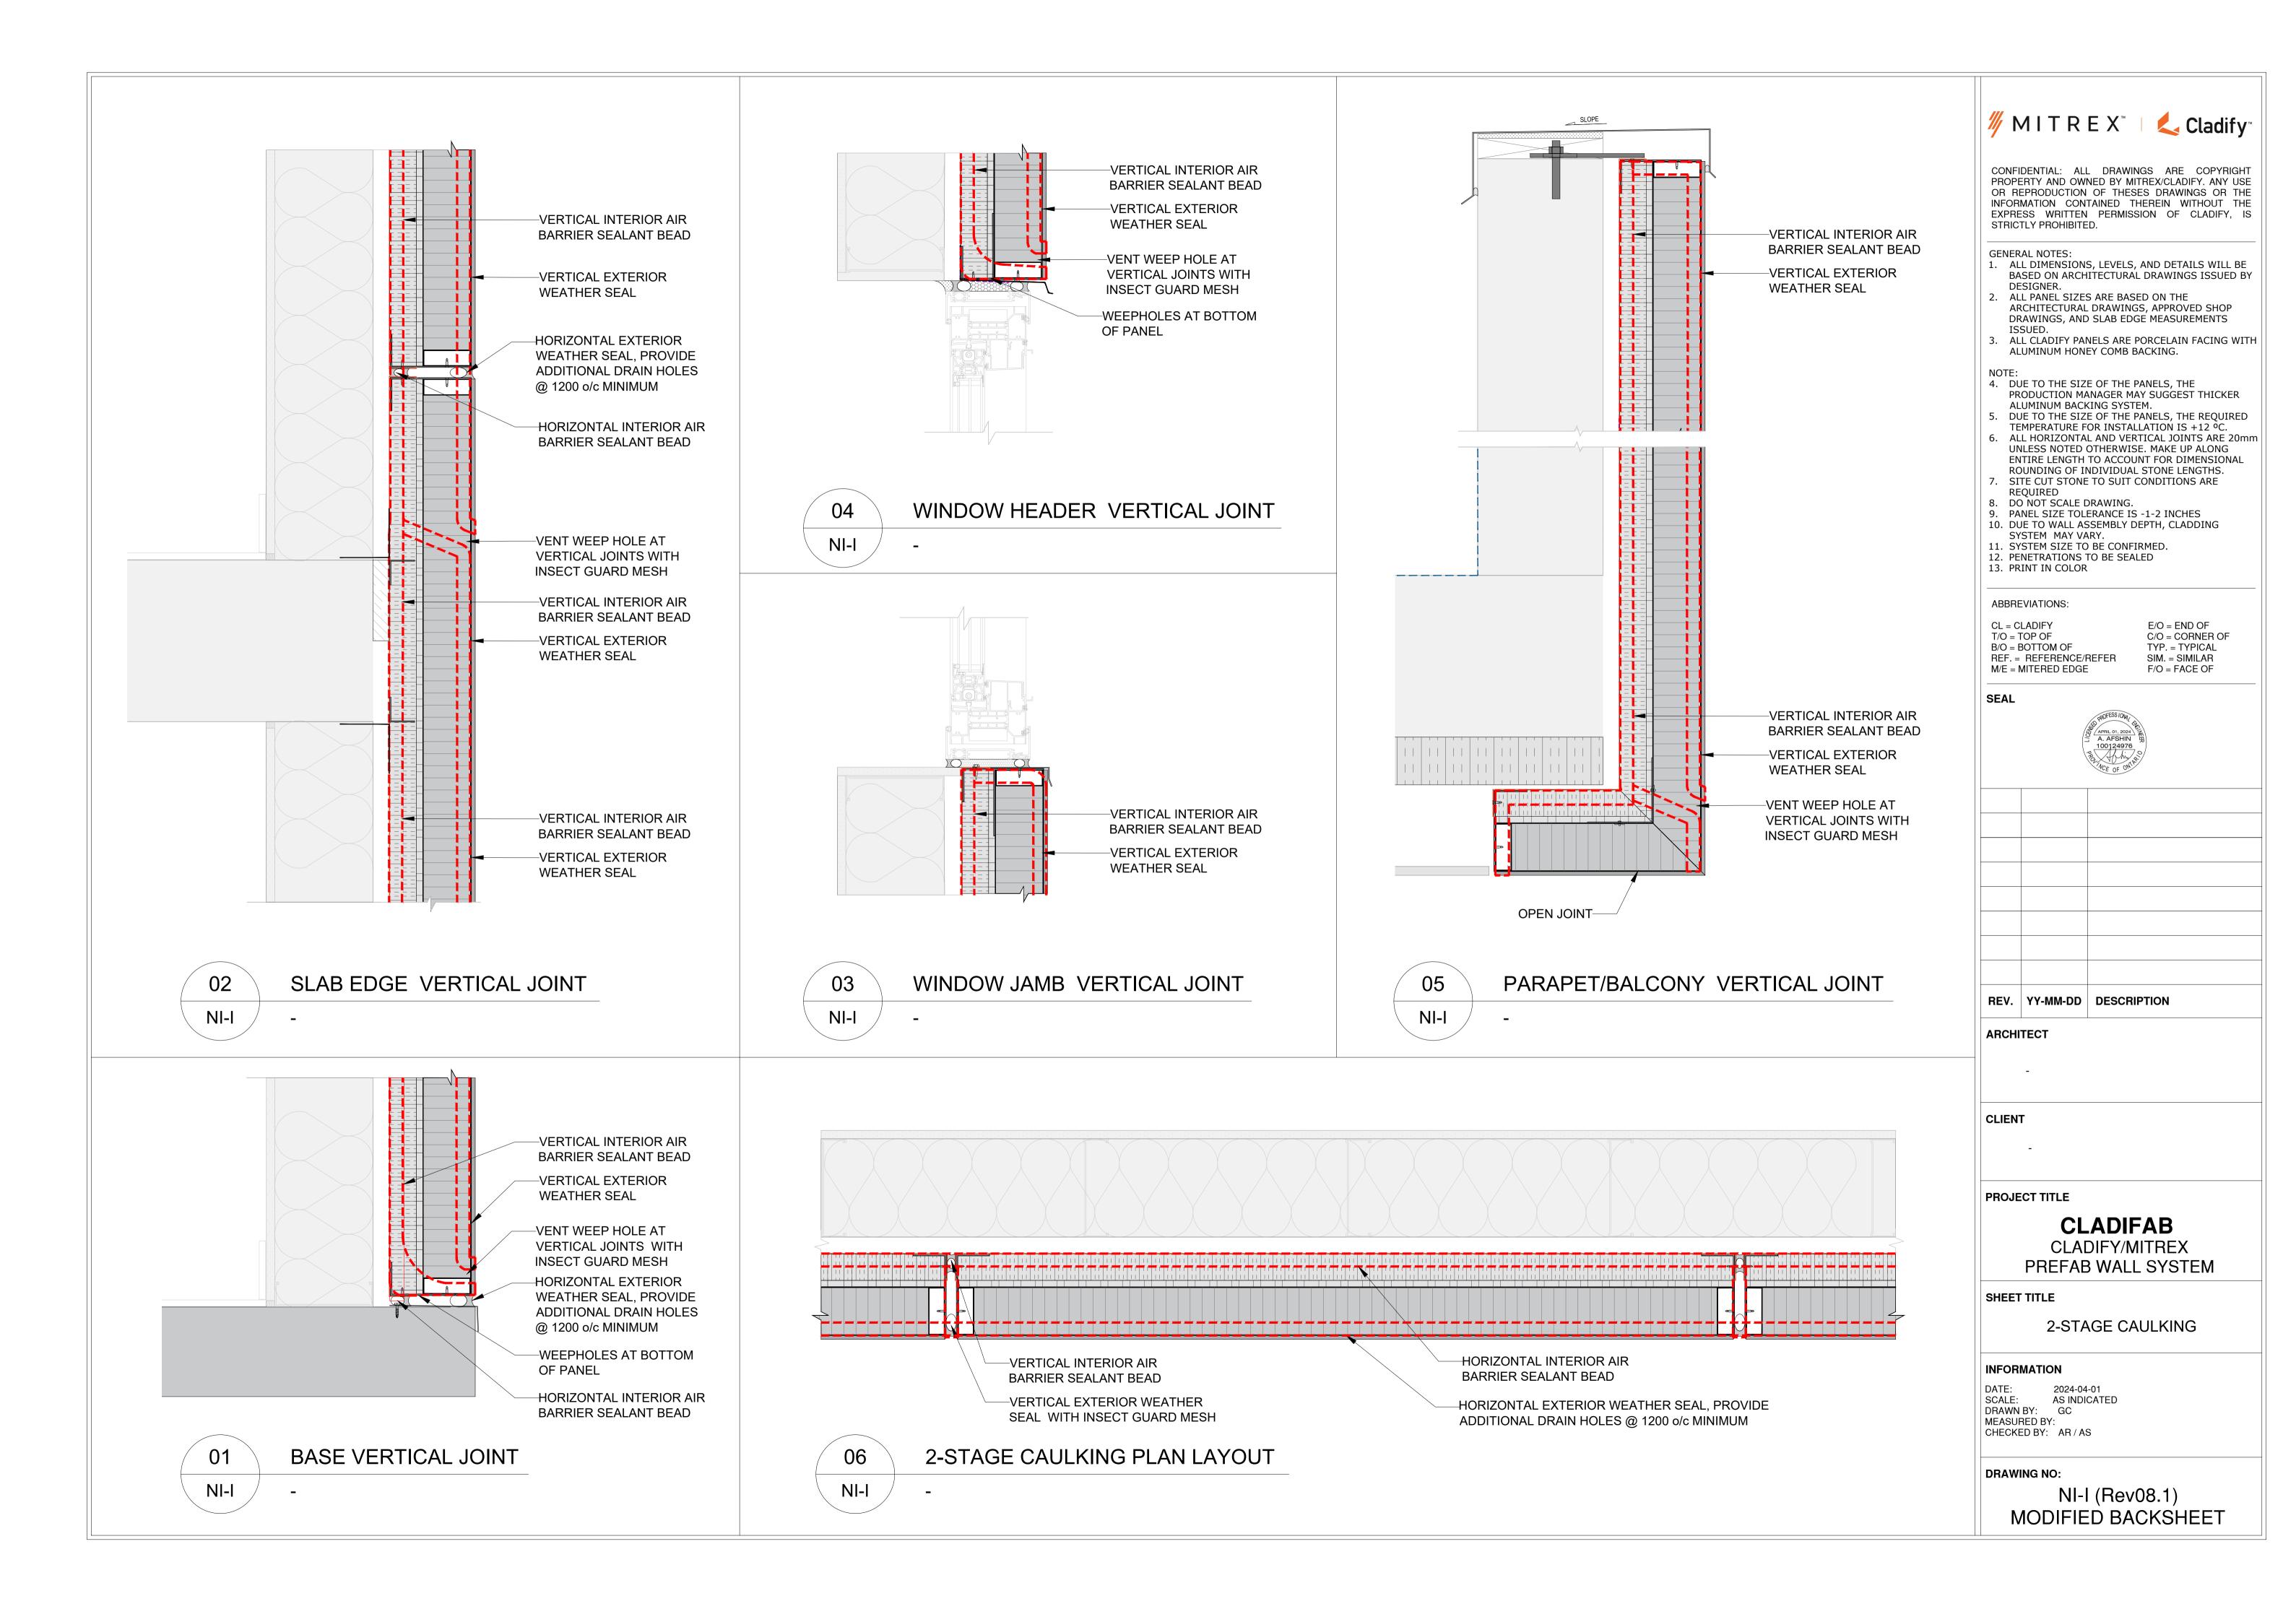

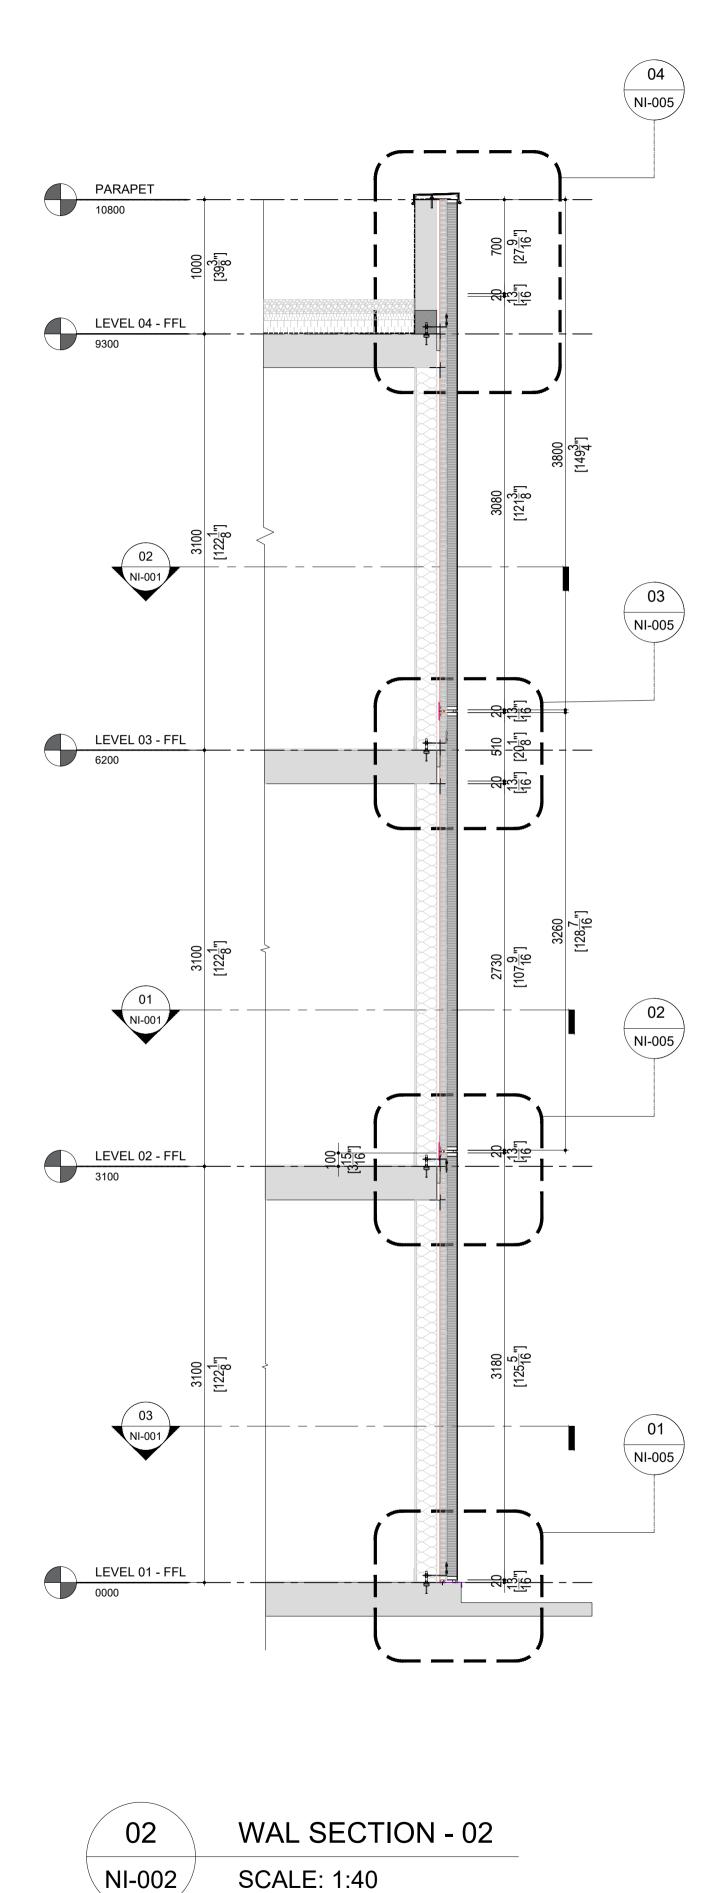

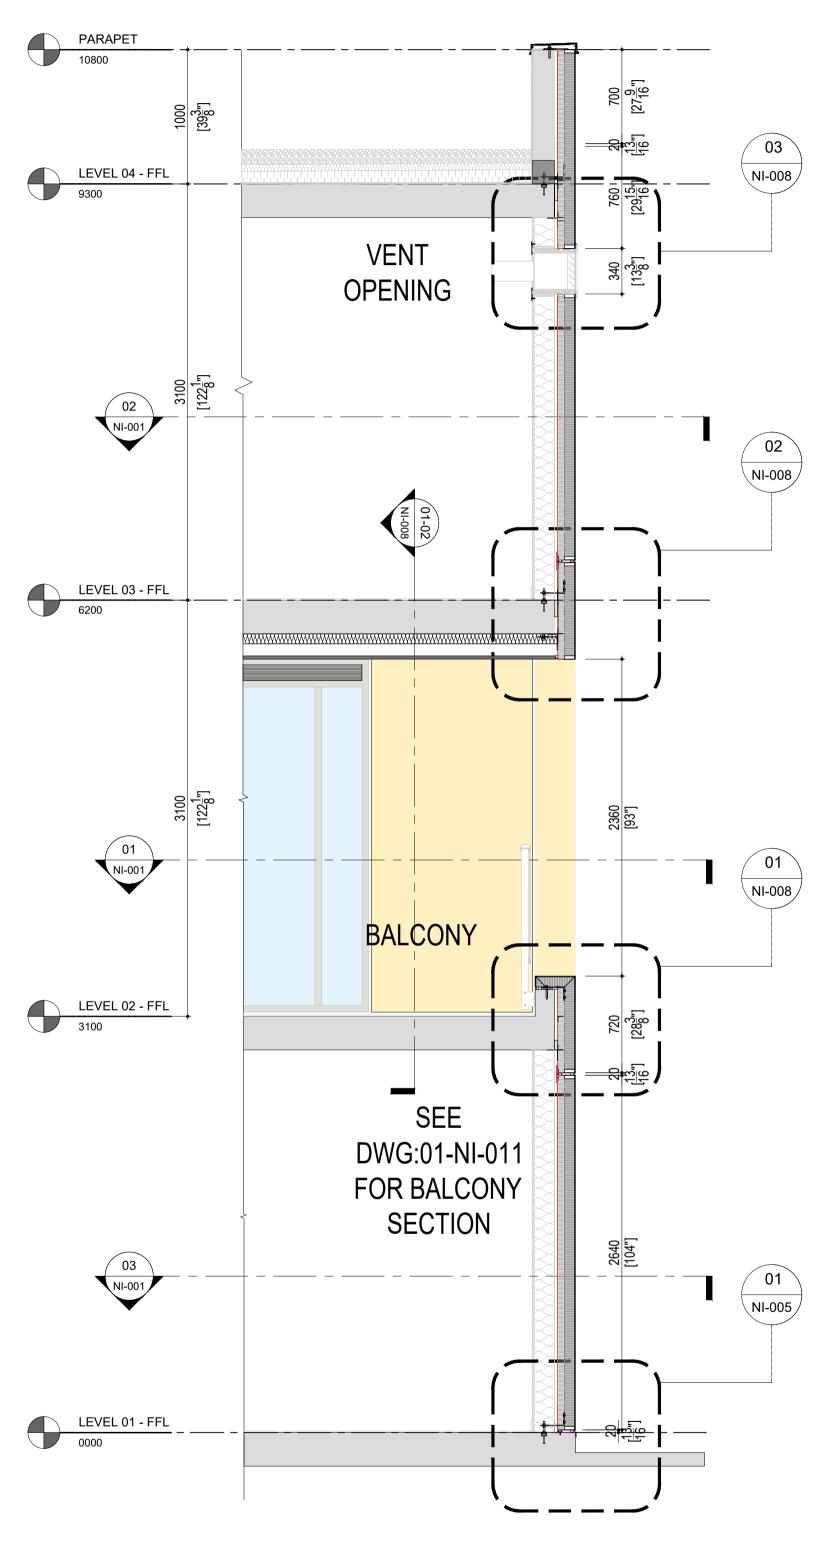

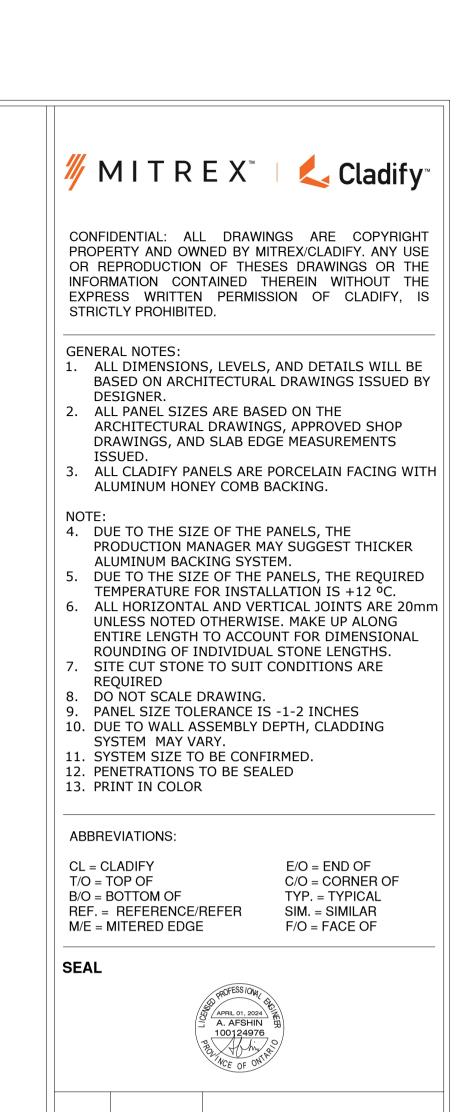

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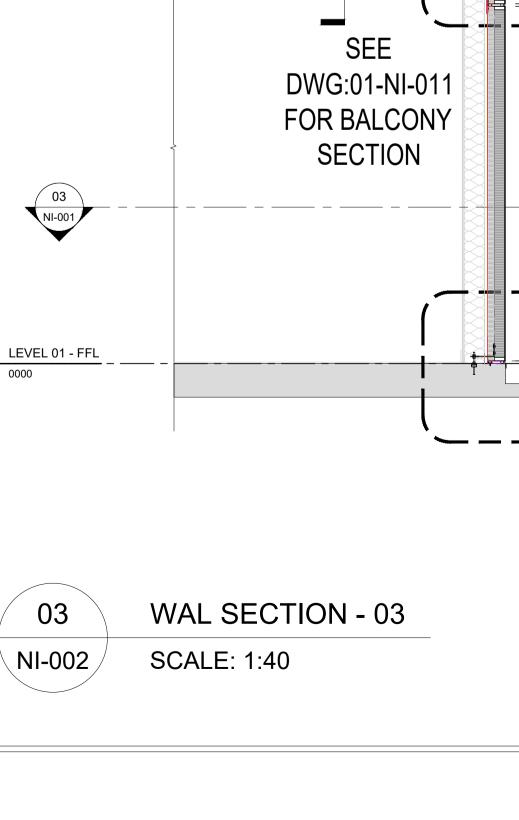
WALL SECTIONS


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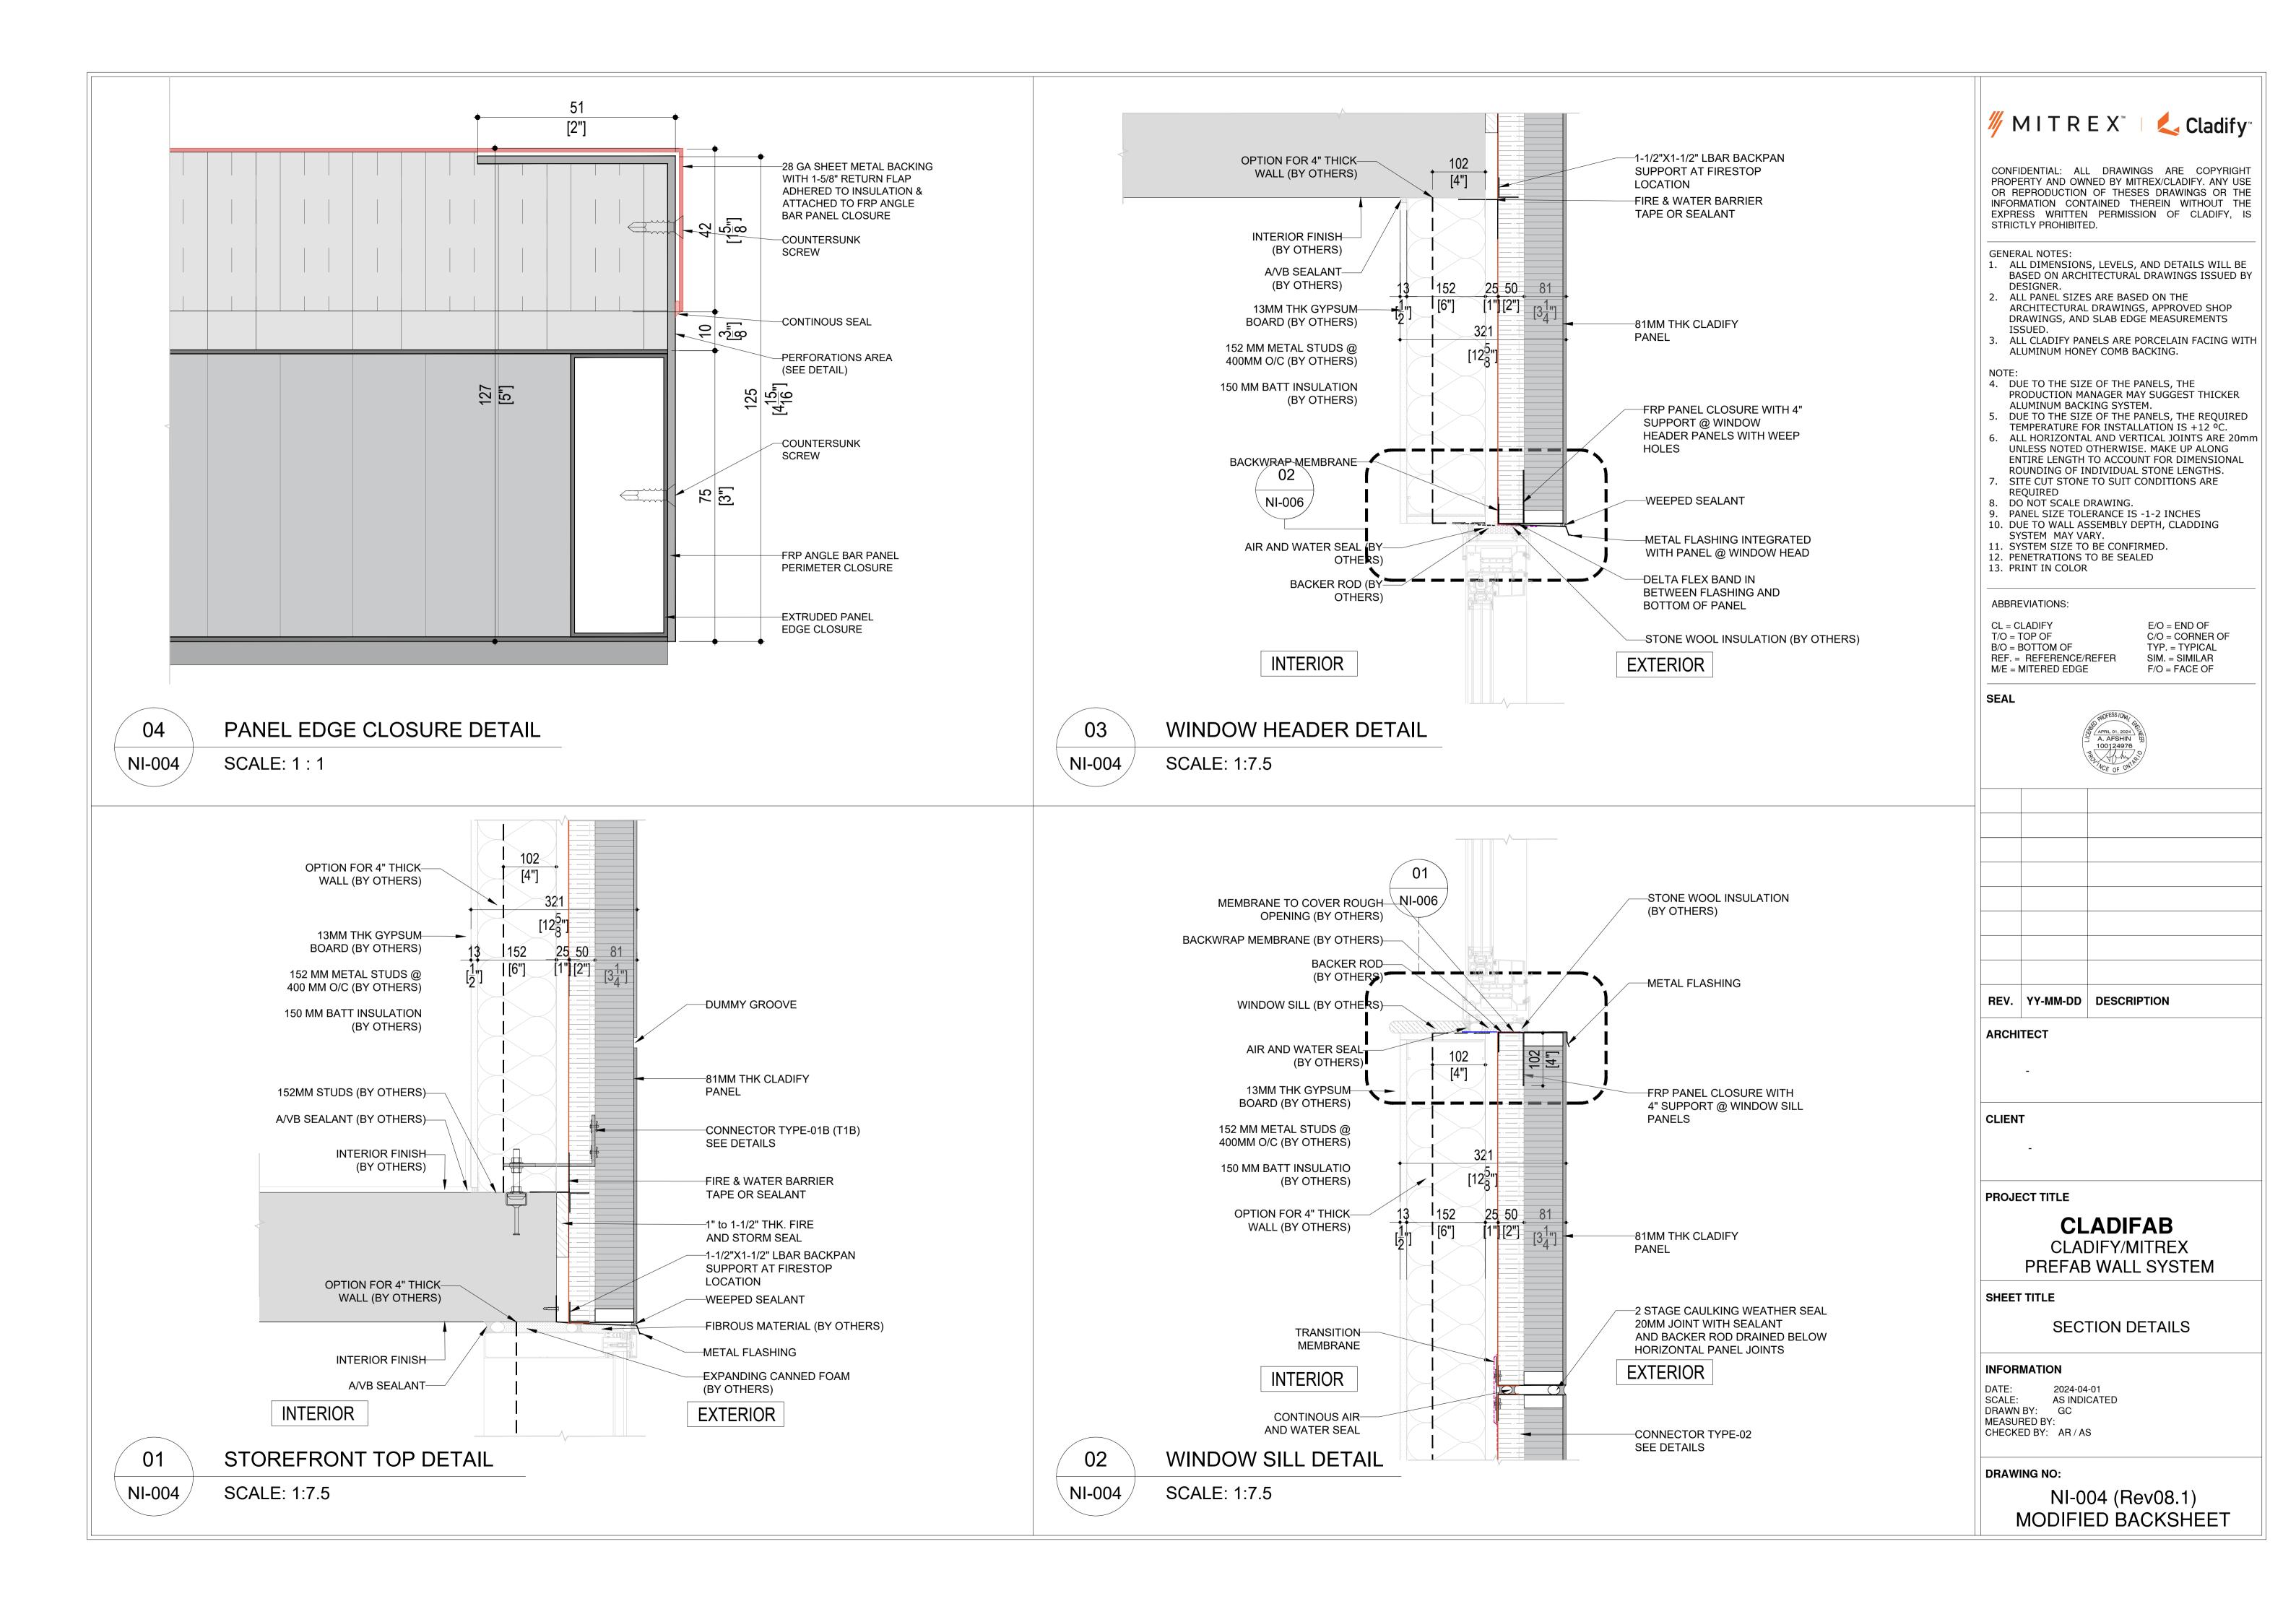
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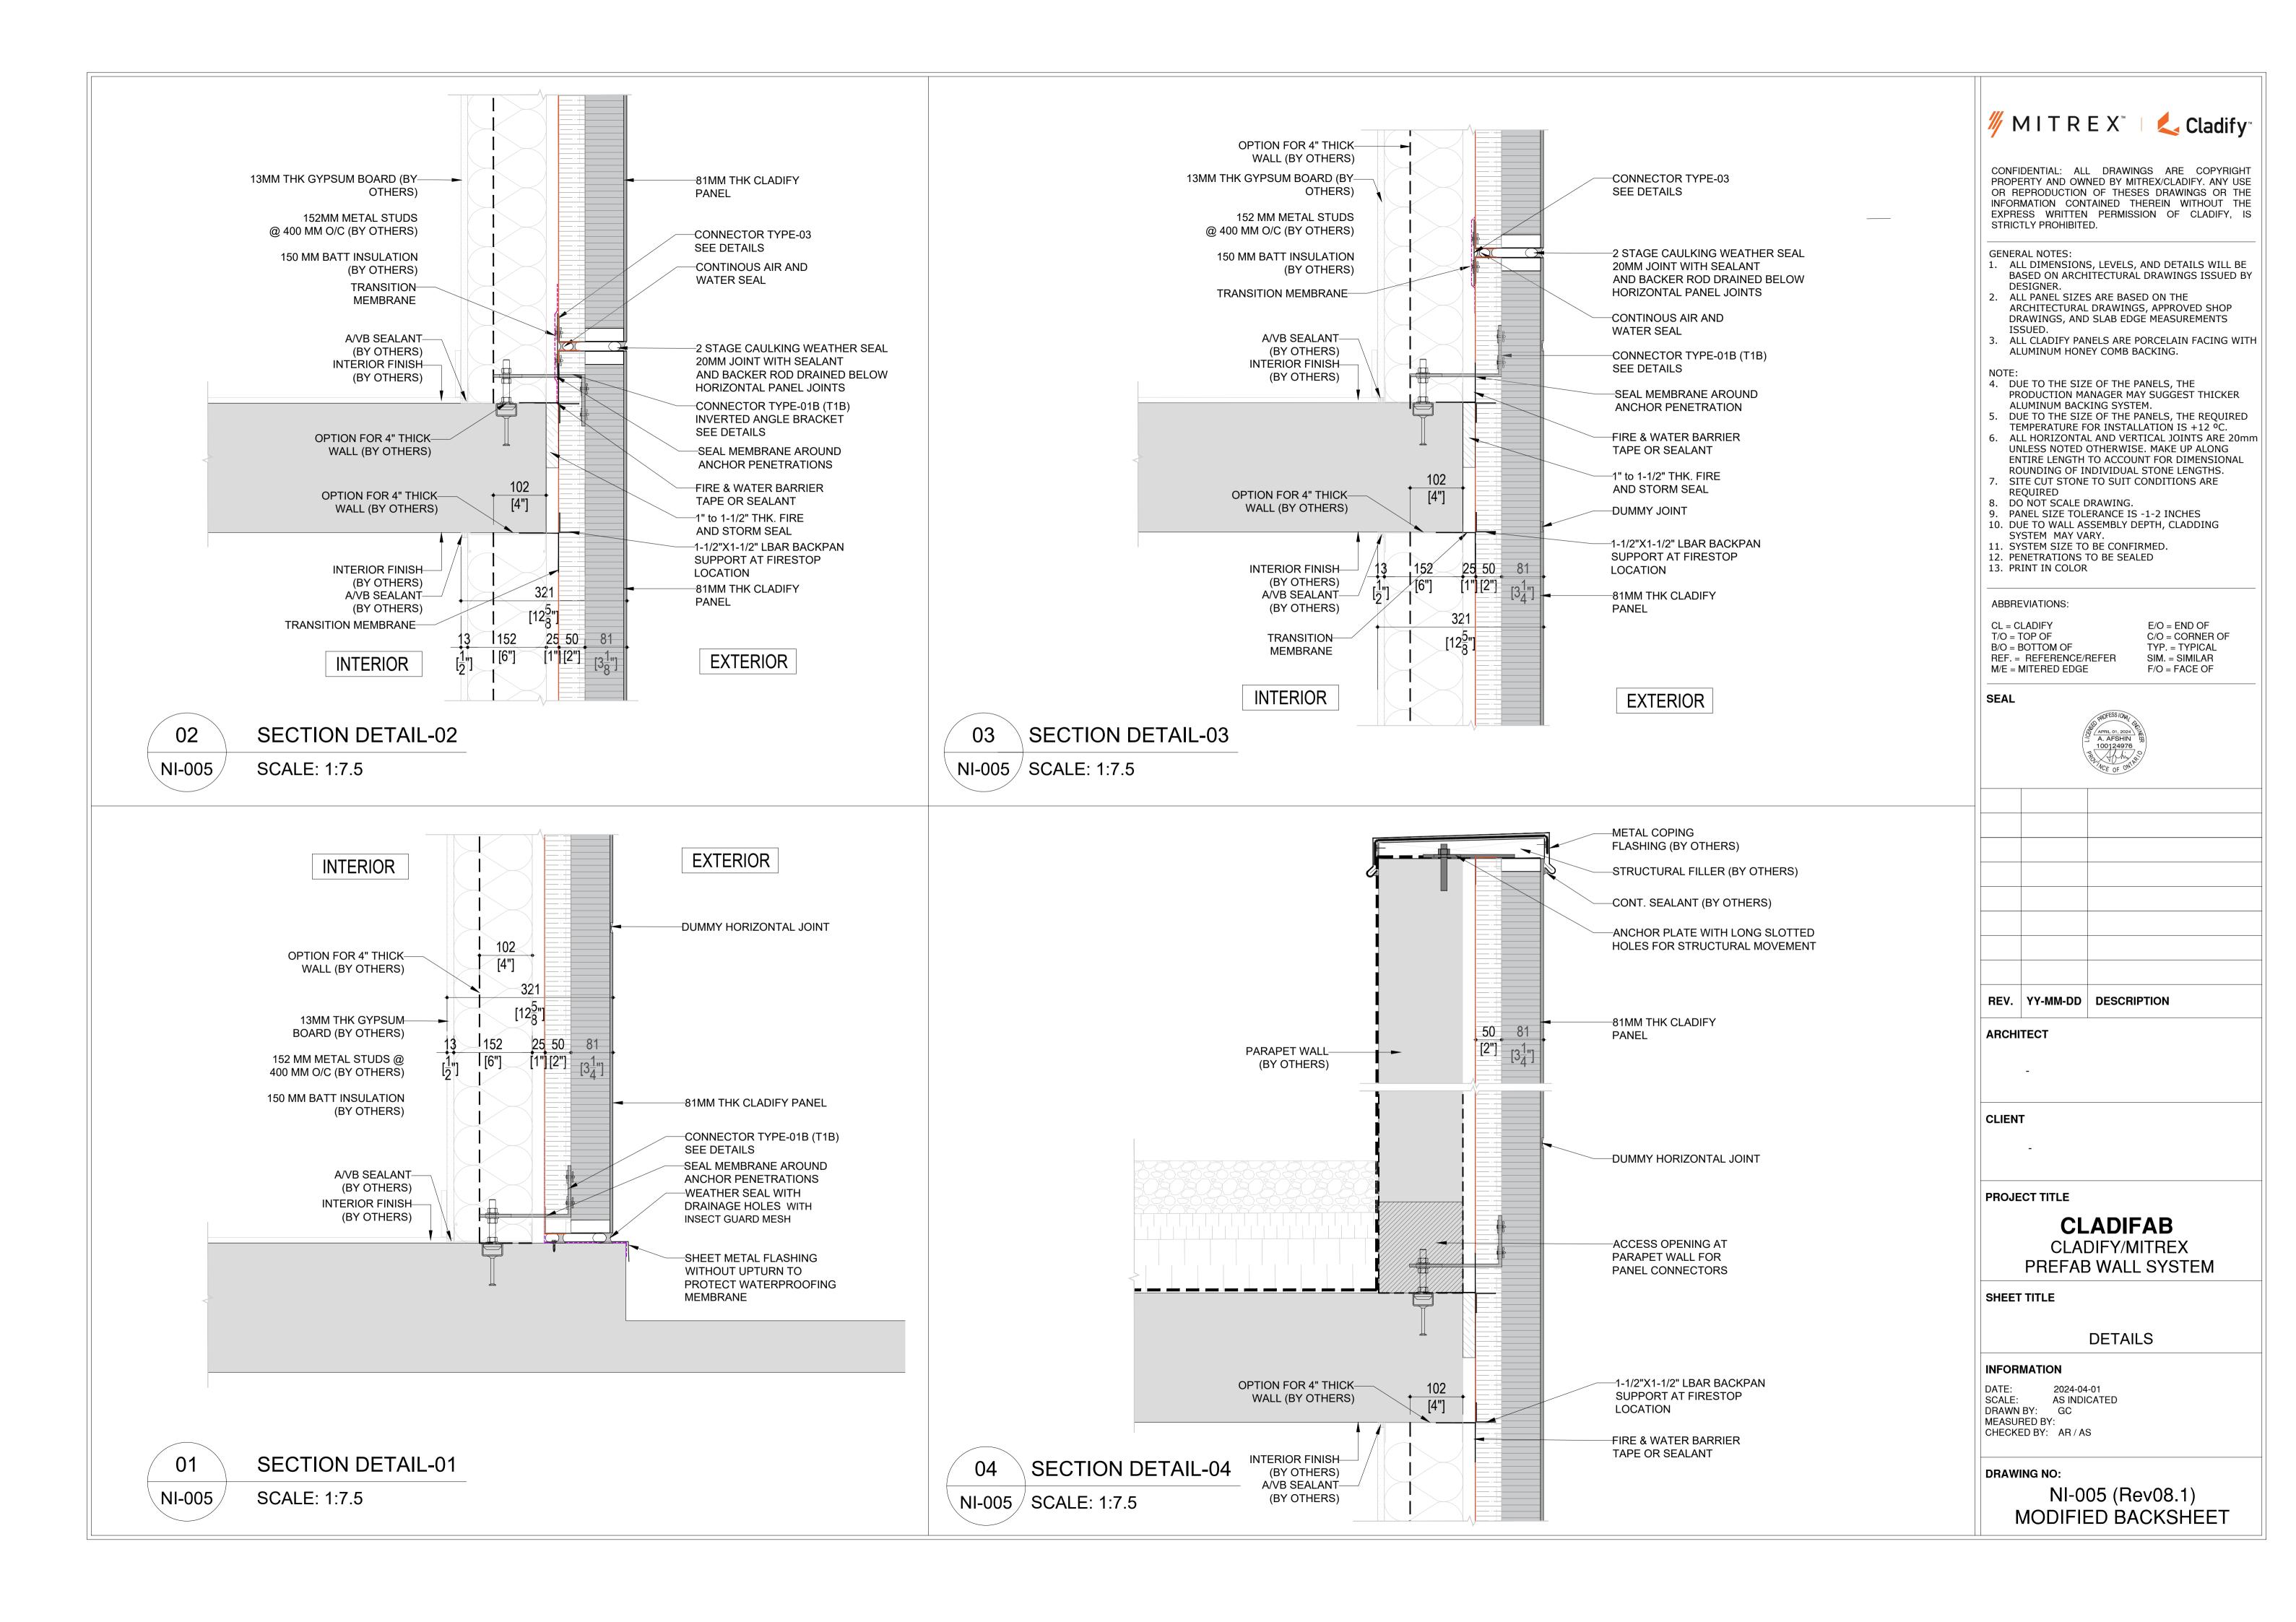
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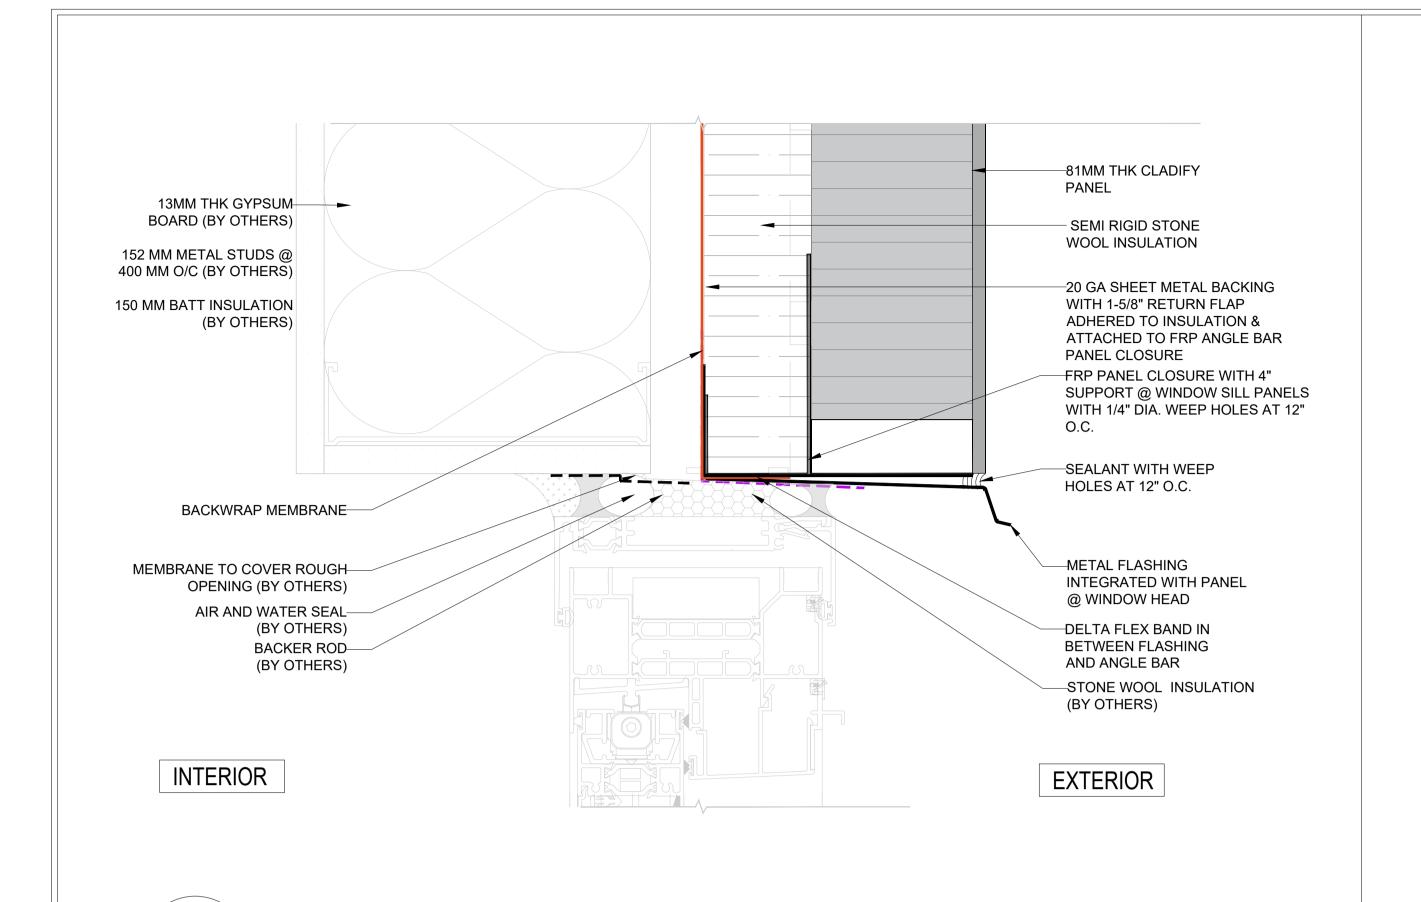
NI-002 (Rev08.1) MODIFIED BACKSHEET









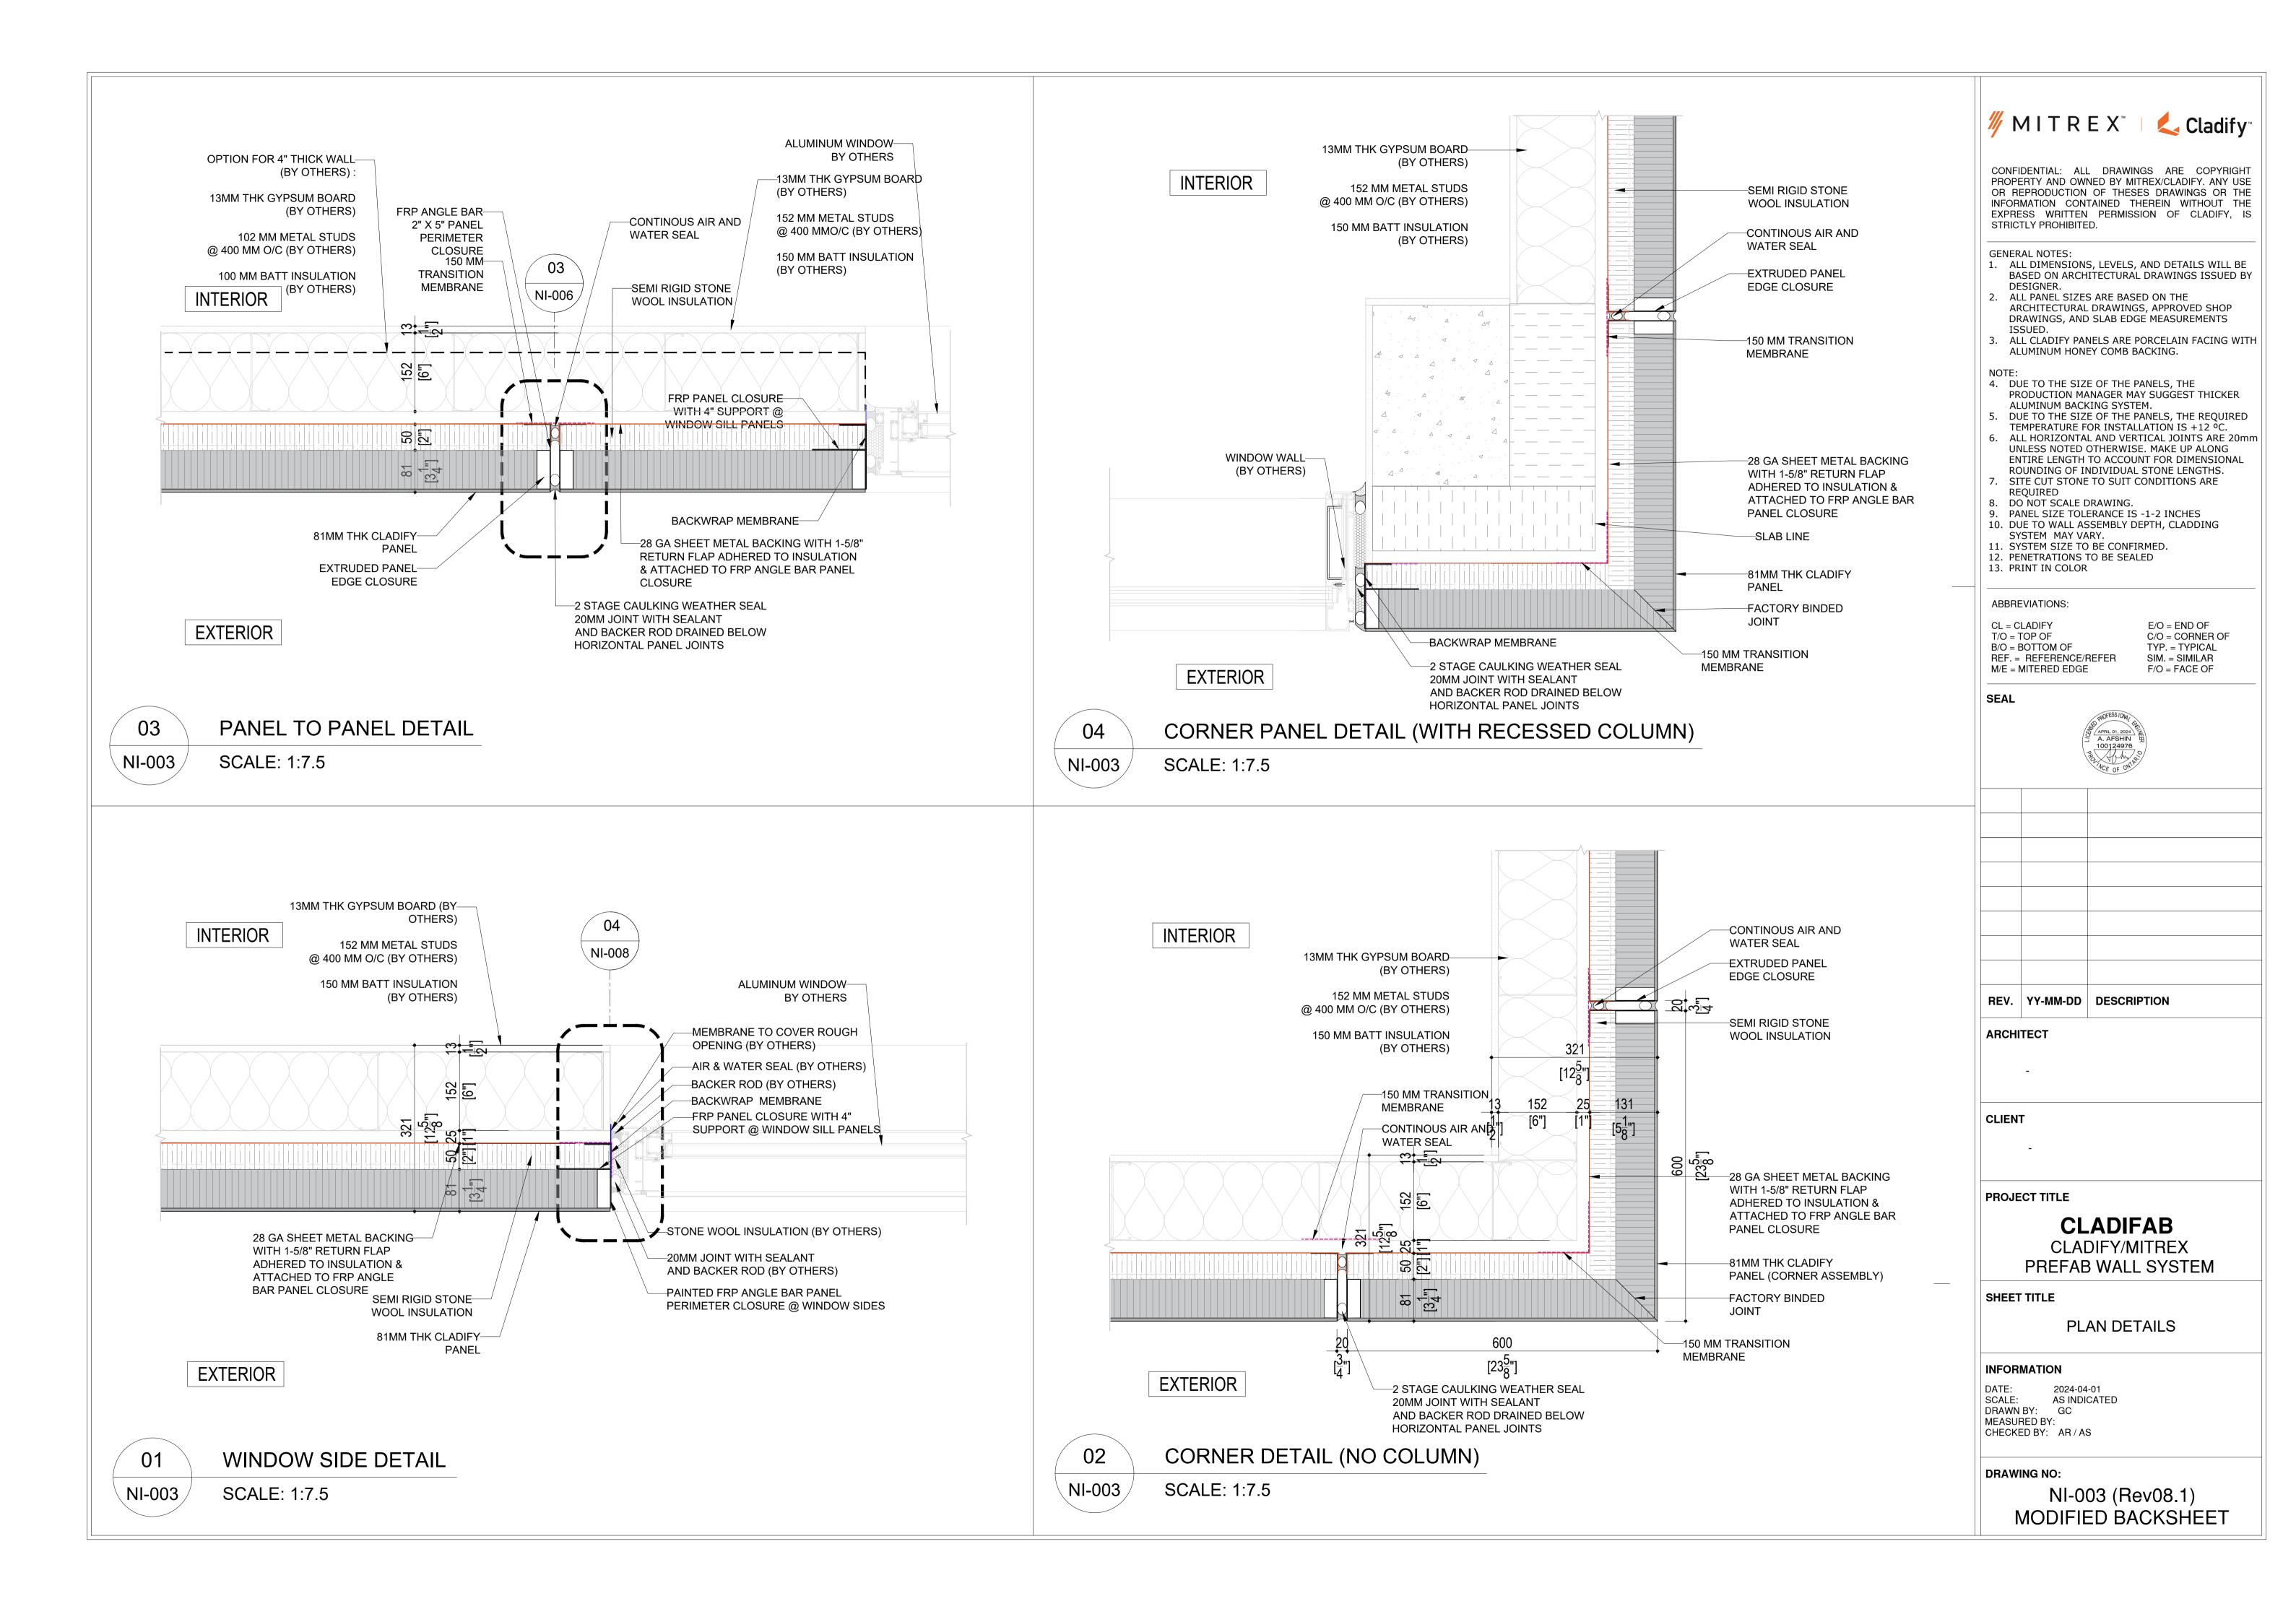

SECTION SPOT DETAIL- WINDOW TOP

SECTION SPOT DETAIL- WINDOW SILL

SCALE: 1:2.5

NI-006

SCALE: 1:2.5

NI-006

- Drainage space Backer rod Sealant Sealant Backer rod Exterior face of cladding Drainage opening

NI-006

NI-006

SCALE: 1:1

CONCEPT OF 2 STAGE CAULKING OF CLADIFY PANELS

NDTS

NO-ORGANIC SHIMS (BY-STONE WOOL INSULATION (BY OTHERS) BACKWRAP MEMBRANE-BACKER ROD(BY OTHERS)-AIR AND WATER SEAL--20MM JOINT WITH SEALANT (BY OTHERS) AND BACKER ROD WITH WEEPHOLES (BY OTHERS) WINDOW SILL (BY OTHERS)-METAL FLASHING MEMBRANE TO COVER ROUGH OPENING (BY OTHERS) FRP PANEL CLOSURE WITH 4" SUPPORT @ WINDOW SILL 13MM THK GYPSUM BOARD **PANELS** (BY OTHERS) 152 MM METAL STUDS @ -20 GA SHEET METAL BACKING WITH 400 MM O/C (BY OTHERS) 1-5/8" RETURN FLAP ADHERED TO **INSULATION & ATTACHED TO FRP** ANGLE BAR PANEL CLOSURE 150 MM BATT INSULATION SEMI RIGID STONE (BY OTHERS) WOOL INSULATION -81MM THK CLADIFY INTERIOR **EXTERIOR** 

150MM TRANSITION MEMBRANE— INTERIOR SEMI RIGID STONE WOOL INSULATION CONTINOUS AIR AND WATER SEAL CLADIFY PANEL— 20 2 STAGE CAULKING WEATHER SEAL-20MM JOINT WITH SEALANT EXTERIOR AND BACKER ROD DRAINED BELOW HORIZONTAL PANEL JOINTS PLAN SPOT DETAIL-01 - CAULKING



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REV. YY-MM-DD DESCRIPTION

**ARCHITECT** 

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**CLADIFAB CLADIFY/MITREX** PREFAB WALL SYSTEM

SHEET TITLE


**DETAILS** 


INFORMATION

AS INDICATED SCALE: DRAWN BY: GC MEASURED BY: CHECKED BY: AR / AS

DRAWING NO:

NI-006 (Rev08.1) MODIFIED BACKSHEET

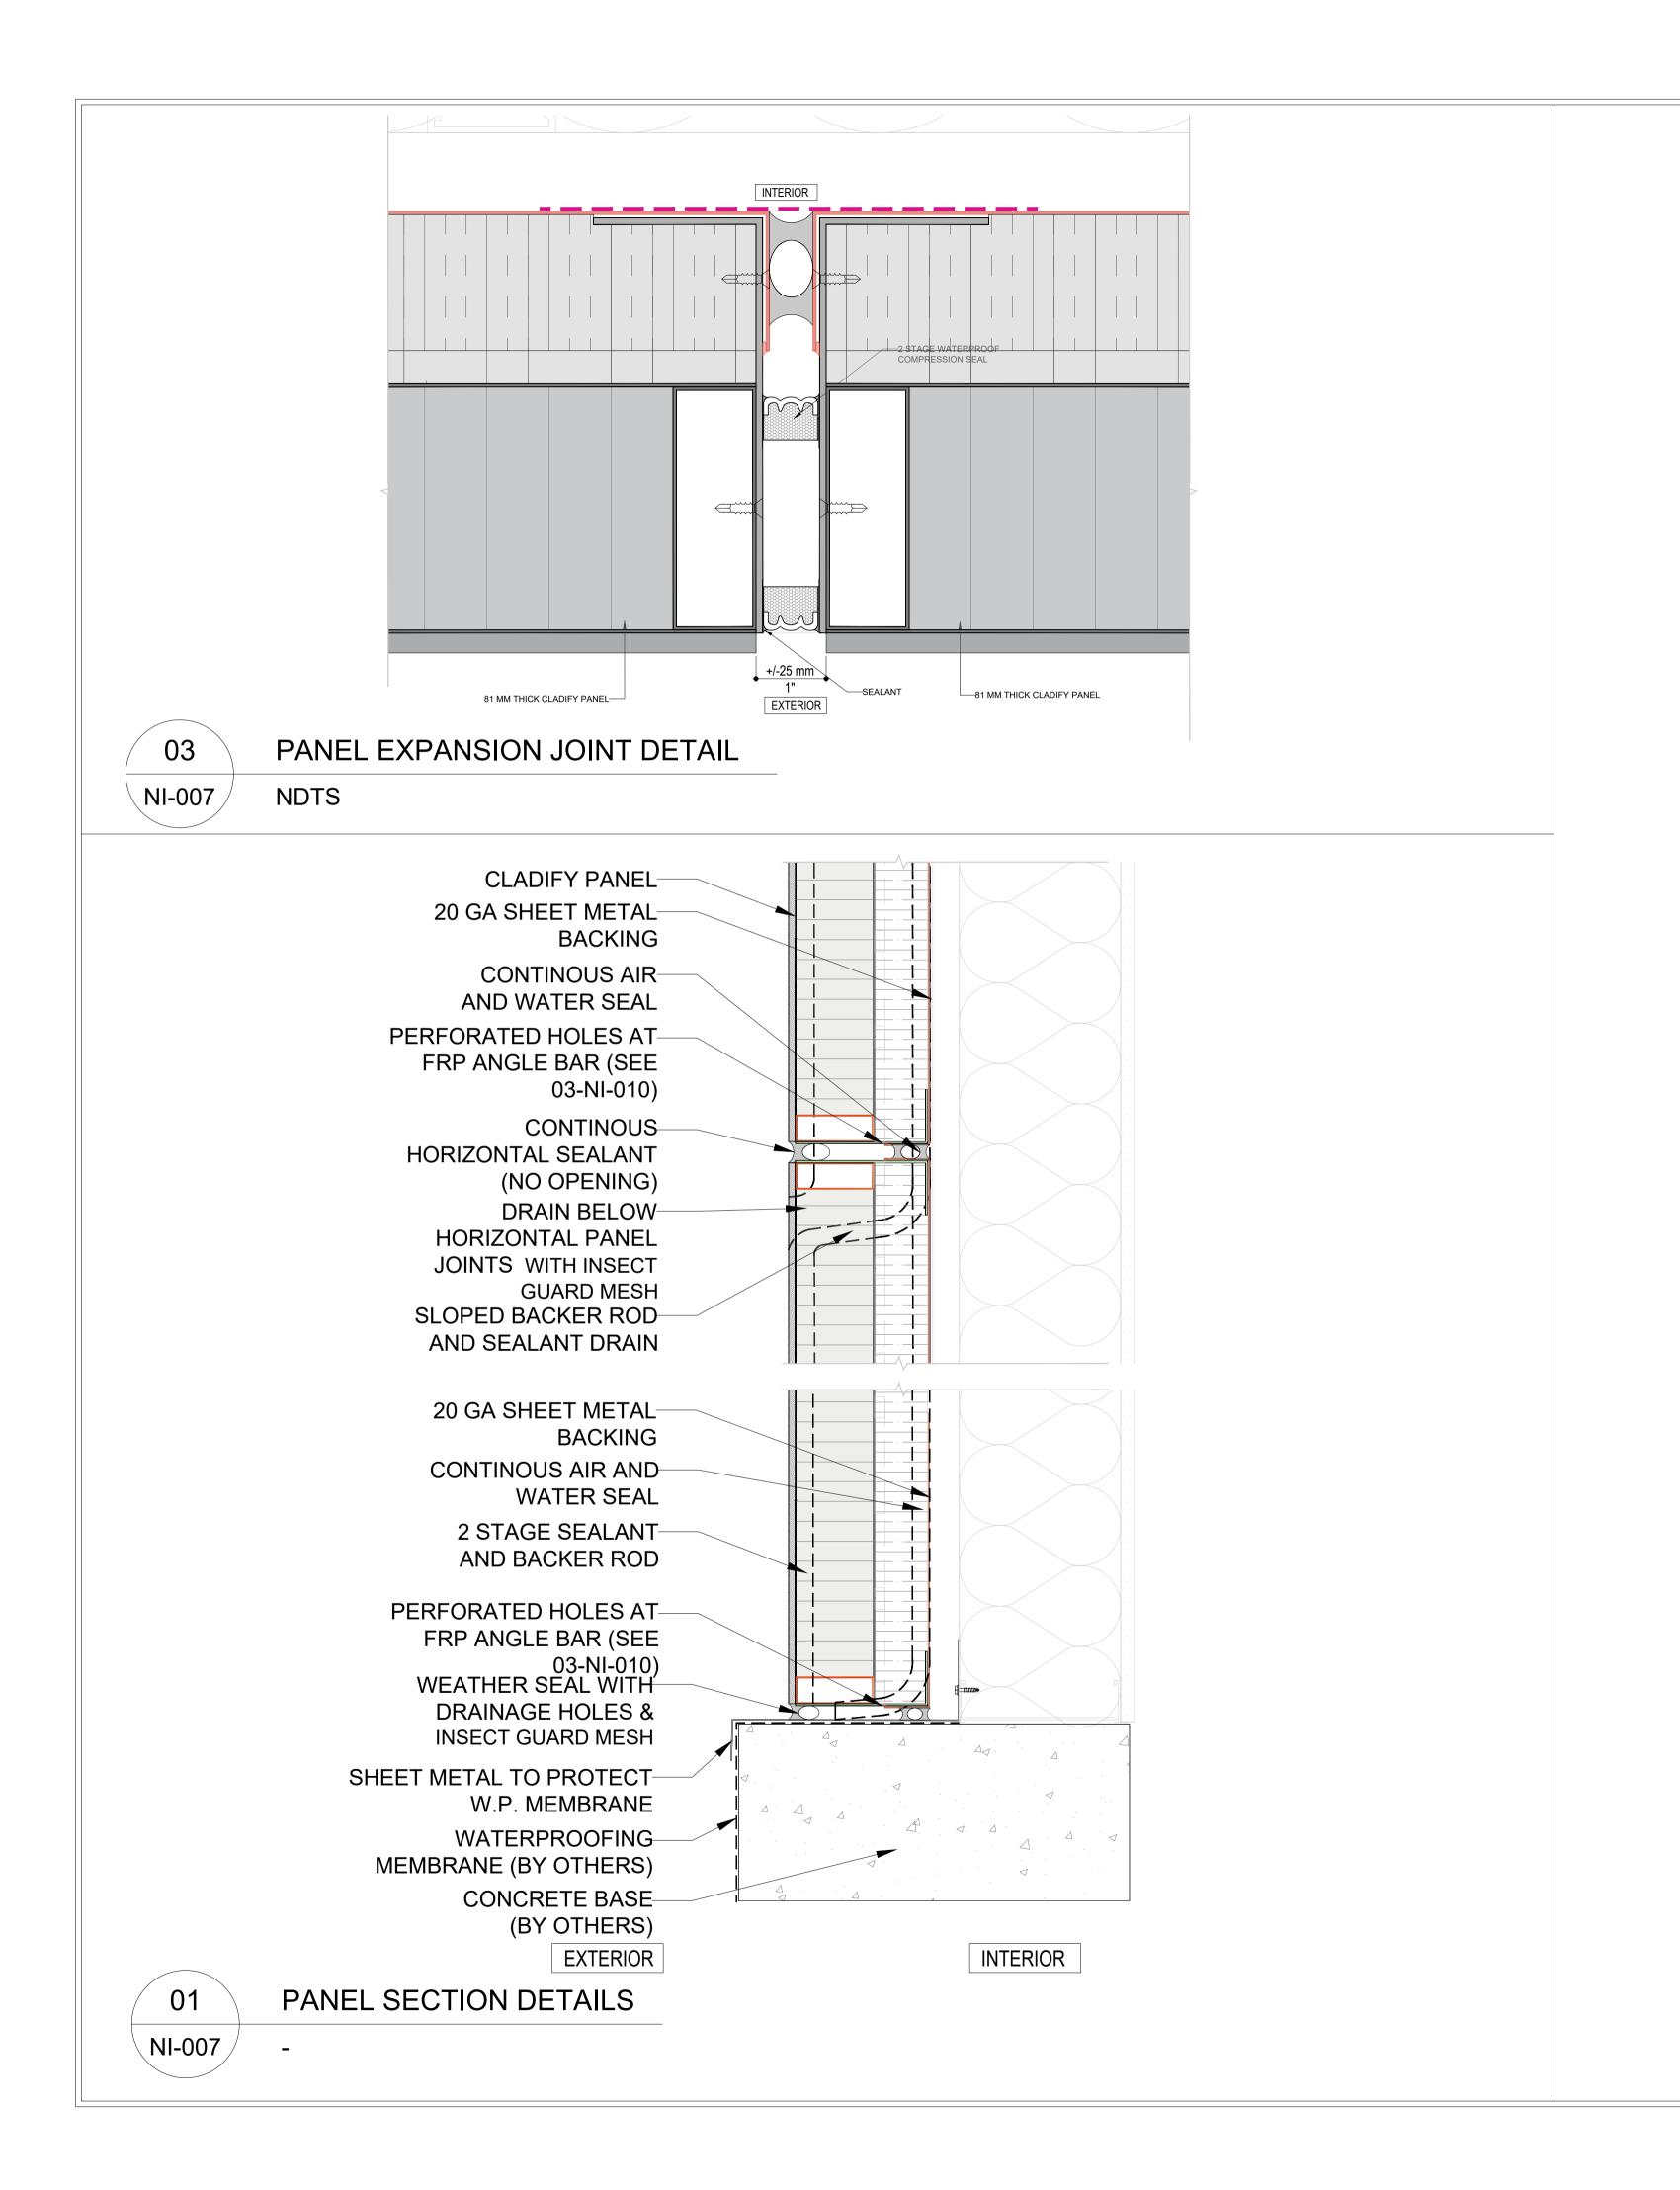

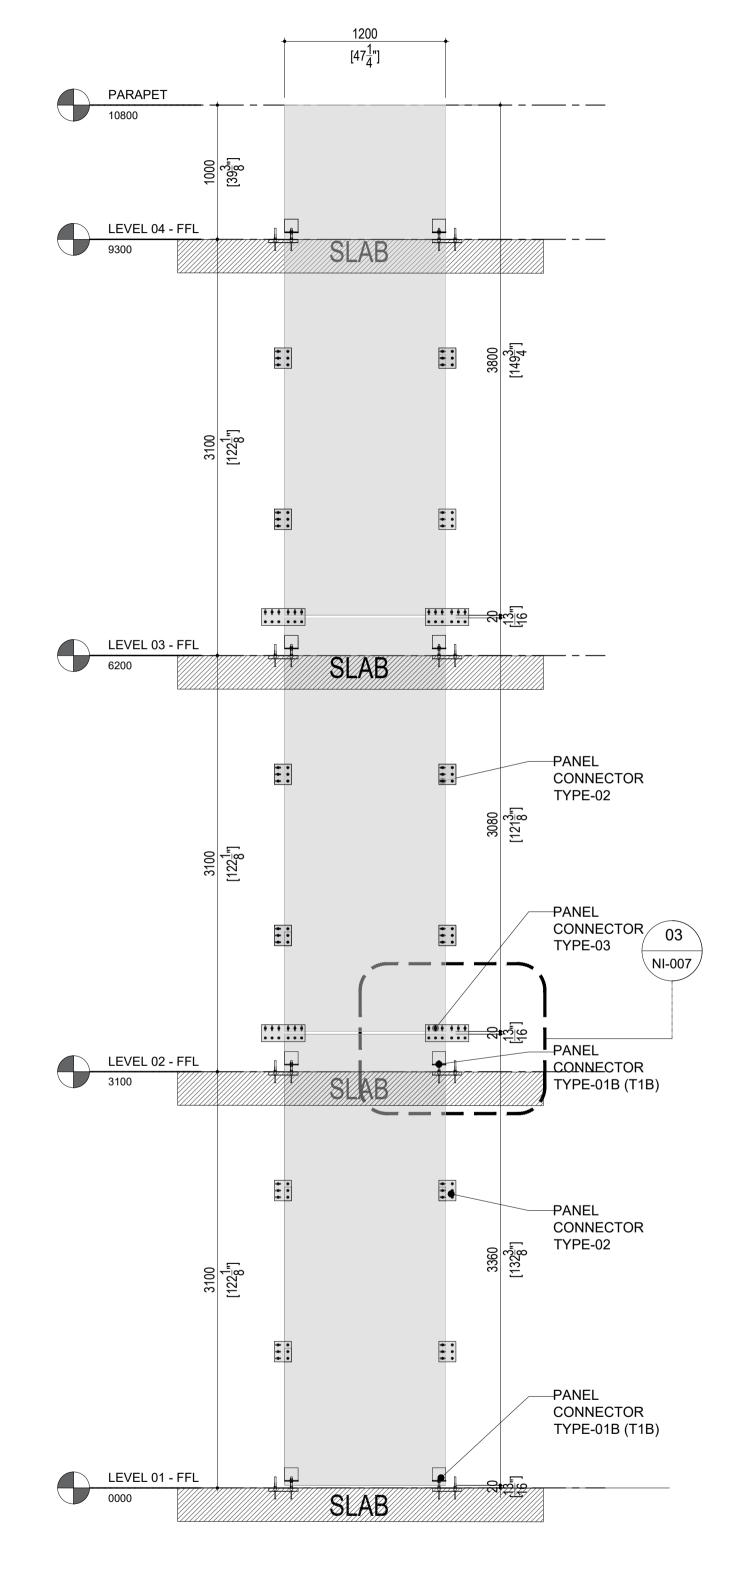

SINGLE LINE PANEL INTERNAL ELEVATION

NI-007





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#### **GENERAL NOTES:**

- 1. ALL DIMENSIONS, LEVELS, AND DETAILS WILL BE BASED ON ARCHITECTURAL DRAWINGS ISSUED BY
- 2. ALL PANEL SIZES ARE BASED ON THE ARCHITECTURAL DRAWINGS, APPROVED SHOP DRAWINGS, AND SLAB EDGE MEASUREMENTS
- 3. ALL CLADIFY PANELS ARE PORCELAIN FACING WITH ALUMINUM HONEY COMB BACKING.

- 4. DUE TO THE SIZE OF THE PANELS, THE PRODUCTION MANAGER MAY SUGGEST THICKER
- ALUMINUM BACKING SYSTEM. 5. DUE TO THE SIZE OF THE PANELS, THE REQUIRED TEMPERATURE FOR INSTALLATION IS +12 °C.
- 6. ALL HORIZONTAL AND VERTICAL JOINTS ARE 20mm UNLESS NOTED OTHERWISE. MAKE UP ALONG ENTIRE LENGTH TO ACCOUNT FOR DIMENSIONAL ROUNDING OF INDIVIDUAL STONE LENGTHS.
- 7. SITE CUT STONE TO SUIT CONDITIONS ARE REQUIRED
- 8. DO NOT SCALE DRAWING.
- 9. PANEL SIZE TOLERANCE IS -1-2 INCHES 10. DUE TO WALL ASSEMBLY DEPTH, CLADDING
- SYSTEM MAY VARY. 11. SYSTEM SIZE TO BE CONFIRMED.
- 12. PENETRATIONS TO BE SEALED 13. PRINT IN COLOR

#### ABBREVIATIONS:

CL = CLADIFY T/O = TOP OFB/O = BOTTOM OFREF. = REFERENCE/REFER M/E = MITERED EDGE

E/O = END OFC/O = CORNER OF TYP. = TYPICAL SIM. = SIMILAR F/O = FACE OF

#### SEAL



REV. YY-MM-DD DESCRIPTION

CLIENT

**ARCHITECT** 

PROJECT TITLE

**CLADIFAB** CLADIFY/MITREX PREFAB WALL SYSTEM

SHEET TITLE

**DETAILS** 

#### **INFORMATION**

DATE: 2024-04-01 SCALE: AS INDICATED DRAWN BY: GC MEASURED BY: CHECKED BY: AR / AS

### DRAWING NO:

NI-007 (Rev08.1) MODIFIED BACKSHEET

